



**DESIGN & CONSTRUCTION GROUP  
THE GOVERNOR NELSON A. ROCKEFELLER  
EMPIRE STATE PLAZA  
ALBANY, NY 12242**

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**ADDENDUM NO. 3 TO PROJECT NO. 47599**

**CONSTRUCTION WORK  
REPAIR ROOF, STATE ARMORY  
321 MANOR ROAD  
STATEN ISLAND, NY**

September 4, 2024

**NOTE:** This Addendum forms a part of the Contract Documents. Insert it in the Project Manual. Acknowledge receipt of this Addendum in the space provided on the Bid Form.

**CONSTRUCTION WORK SPECIFICATIONS**

1. SECTION 071900 WATER REPELLENT COATING: Discard the Section bound in the Project Manual and substitute the accompanying Section (pages 071900 – 1 through 071900 – 3) noted “REVISED 08/28/2024”.
2. SECTION 074113 PREFORMED METAL SOFFIT: Discard the Section bound in the Project Manual.

**APPENDIX**

3. SCHEDULE OF SUBMITTALS: Discard all previously issued versions and substitute the accompanying Document (pages 1 through 5) noted “REVISED 08/28/2024”.

**CONSTRUCTION DRAWINGS**

4. Revised Drawings:
  - a. Drawing Nos. A-011, A-102, A-201, AND A-202 noted “REVISED DRAWING 08/28/2024”, accompany this Addendum and supersede the same numbered previously issued drawings.

**END OF ADDENDUM**

Brady M. Sherlock, P.E.  
Director, Division of Design  
Design & Construction

## SECTION 071900

### WATER REPELLENT COATING

#### PART 1 GENERAL

##### 1.01 RELATED WORK SPECIFIED ELSEWHERE

- A. Masonry Restoration: Section 040121.

##### 1.02 SUBMITTALS

- A. Product Data: Catalog sheets, specifications, and installation instructions for each material specified. Include manufacturer's printed statement of VOC content where appropriate.
- B. Samples: Liquid water repellent; one quart.

##### 1.03 QUALITY ASSURANCE

- A. Field Example:
  - 1. Provide a sample application of not less than 100 sq ft to determine the application method most suitable for the existing substrate conditions and to assure that no staining or discoloration occurs.
  - 2. Select a test area that most accurately represents the actual substrate conditions.
  - 3. Notify the Director's Representative in writing 5 days in advance of the proposed dates and time for the sample application.
  - 4. After curing of the sample application, conduct water spray test to verify that the treatment repels moisture.
  - 5. Do not proceed with the Work until the sample application has been approved by the Director's Representative in writing.
- B. Volatile Organic Compounds (VOCs) Regulatory Requirements: Water Repellants to comply with Chapter III of Title 6 of the official compilation of Codes, Rules and Regulations of the State of New York (Title 6 NYCRR), Part 205 Architectural and Industrial Maintenance (AIM) Coatings.
  - 1. Reactive Penetrating Sealer: VOC content lesss than 350 g/l.

##### 1.04 DELIVERY, STORAGE, AND HANDLING

- A. Deliver materials to the job site in original sealed containers, clearly marked with manufacturer's name, brand, and material description.
- B. Store materials in conformance with the manufacturer's written instructions.

## **1.05 PROJECT CONDITIONS**

- A. Do not apply water repellent on surfaces that contain moisture or frost. Comply with the manufacturer's written requirements for temperature and humidity conditions.
- B. Do not apply water repellent until restoration of the substrate has been completed and joint sealants applied.

## **PART 2 PRODUCTS**

### **2.01 COMPANIES**

- A. Evonik Degussa Corporation, 379 Interpace Parkway, P. O. Box 677, Parsippany, NJ 07054-0677, (800) 828-0919, [www.protectosil.com/protectosil/en/nafta/](http://www.protectosil.com/protectosil/en/nafta/).
- B. Master Builders Solutions Construction Systems, LLC; 889 Valley Park Drive, Shakopee, MN 55379; (800) 433-9517; [www.master-builders-solutions.com/en-us](http://www.master-builders-solutions.com/en-us).
- C. PROSOCO, Inc., 3741 Greenway Circle, Lawrence, KS 66046, (800) 255-4255, [www.prosoco.com](http://www.prosoco.com).

### **2.02 MATERIALS**

- A. Liquid Water-Repellent:
  - 1. Product Description: A non-toxic, breathable, clear water repellent intended for single-coat application, that, after cure, leaves no visible surface residue, color, or gloss. Silicone or acrylic based materials are not acceptable.
  - 2. Type 1 Water Repellent: Acceptable products include the following:
    - a. SL100 by PROSOCO, Inc.
    - b. MasterProtect H 1000, by Master Builders Solutions Construction Systems US, LLC.
    - c. Protectosil Chem-Trete PB 350, by Evonik Degussa Corp.

## **PART 3 EXECUTION**

### **3.01 PREPARATION**

- A. Protection: Protect existing construction not required to be treated. Cover live vegetation.
- B. Surface Preparation: Comply with manufacturer's printed recommendations and the following:
  - 1. Remove dust, dirt, oil, efflorescence, loose particles, and all other foreign matter. Allow prepared surfaces to dry thoroughly.

**3.02 APPLICATION**

- A. Apply one coat of water repellent. Apply material in accordance with the manufacturer's printed instructions and the approved field example.
- B. Apply water repellent material by low pressure airless spray method unless otherwise approved by the Director's Representative.
- C. After curing of the water repellent, test all treated surfaces with a water spray. Dry and re-coat all areas that show water absorption. If necessary, repeat the application until specified water repellency has been obtained.

**3.03 CLEANING**

- A. Remove protective materials after water repellent Work has been completed.
- B. Restore all adjacent surfaces, defaced by the Work, to conditions equal to or better than those existing prior to the start of water repellent applications.

**END OF SECTION**



**SCHEDULE OF SUBMITTALS**

**PROJECT NO.: 47599 - C**

**FACILITY: STATE ARMORY - STATEN ISLAND**

**CONTRACTOR:**

**PROJECT MANAGER:**

**DESIGN CONSULTANT: SPRING LINE DESIGN ARCHITECTURE+ENGINEERING**

**ENGINEER-IN-CHARGE:**

**LEGEND**

- PACK:** SUBMITTAL PACKAGE
- SD:** SHOP DRAWINGS
- PD:** PRODUCT DATA
- EPD:** ENVIRONMENTAL PRODUCT DECLARATION
- SAM:** SAMPLES
- QCS:** QUALITY CONTROL SUBMITTALS
- LEED:** LEED SUBMITTALS
- CCS:** CONTRACT CLOSEOUT SUBMITTALS
- SUBMITTAL REVIEW RESPONSIBILITY:**
- F:** OGS FIELD OFFICE
- F/O:** OGS FIELD OFFICE / OFFICE (ALBANY)
- D:** CONSULTANT / DESIGNER
- S:** OGS SCHEDULING DEPARTMENT
- RSM:** Regional Safety Manager

**INSTRUCTIONS TO THE CONTRACTOR**

1. Refer to **Section 013300 Submittals** of the Project Manual for general requirements regarding submittals and to **Section 017716 - CONTRACT CLOSEOUT** for project closeout submittals.
2. Refer to Sections of the specifications indicated herein for details of the requirements for each submittal listed.
3. Indicate in the rows (spaces) following each item:
  - a. Critical submittals and long lead items (mark with an 'X'). Some critical submittals may already be identified by the design team. Confirm that these are critical submittals.
  - b. The date the item will be submitted, and date approval is required (allow at least 3 weeks), and the date delivery of the material or equipment is necessary for completion of the work in accordance with the Progress Schedule. The date entered for the submittal is the last date a substitution will be considered. Proposed substitutions must be made prior to the date entered if more than one substitution is to be submitted for approval. Spaces which contain N/A do not require dates.
4. An example of a Submittal Transmittal (BDC-42) can be located at: <http://www.ogs.ny.gov/BU/DC/forms/ContractorConstForms.asp>
5. Submit Contract Closeout Submittals (CCS) prior to final inspection.

**INSTRUCTIONS TO THE CONSULTANT / DESIGNER**

1. Cut and paste required information from each Division (Div.X) tab and place in the S.O.S. tab.
2. Delete Division (Div.X) tabs after the S.O.S. tab has been in-filled.
3. Indicate F, F/O or D in column E. Items in Div.1 have defaults that can be modified as necessary.
4. Indicate items that are critical submittals in column F.

**Note:**

The following list of submittals is furnished for your convenience in scheduling submittals. The list is not warranted to be complete and does not take precedence over the contract documents. Enter additional submittals, as required and modify this schedule to the specific project. This S.O.S. will be used to populate the submittals website log.



SCHEDULE OF SUBMITTALS								
PROJECT NO.: 47599 - C								
SUBMITTALS FOR APPROVAL				Send to:	Critical Submittals	Contractor's Projected Dates Allow at least 4 weeks for Approval (allows time for any resubmission)		
Spec Section	Sub Section	Type	Description	F F/O D S	Mark "X" for all that apply	Projected Transmittal Date:	Projected Approval Date:	Projected Delivery Date:
<b>007213</b>			<b>GENERAL CONDITIONS</b>					
<b>007213</b>	<b>6.1</b>	<b>PD</b>	ARTICLE 6: Designate in writing competent supervision and/or management representatives as required - <b>include contact number in case of an emergency after work hours, including weekends and holidays (see 011000 Summary of Work)</b>	F				
<b>007213</b>	<b>8.1</b>	<b>PD</b>	ARTICLE 8: Permits and licenses	F				
<b>011100</b>			<b>SAFETY</b>					
<b>011100</b>	<b>1.04.A</b>	<b>QCS</b>	Site Specific Safety Plan	RSM				
<b>011100</b>	<b>1.04.B</b>	<b>QCS</b>	Employee Safety Orientation Training and Certificates	F				
<b>011100</b>	<b>1.04.D</b>	<b>QCS</b>	Emergency Action and Evacuation Plan	F				
<b>013300</b>			<b>SUBMITTALS</b>					
<b>013300</b>	<b>1.07.B</b>	<b>PD</b>	Schedule of Submittals (Fill in the SET DATES column)	F	X			
<b>013300</b>	<b>1.07.A</b>	<b>QCS</b>	Submittal Coordinator Qualifications	F/O	X			
<b>017716</b>			<b>CONTRACT CLOSEOUT</b>					
<b>017716</b>	<b>1.04</b>	<b>CCS</b>	Project Record Documents	F				
<b>017716</b>	<b>1.05</b>	<b>CCS</b>	Operation and maintenance, 2 copies	F				
<b>017716</b>	<b>1.06</b>	<b>CCS</b>	Warranties	F				
<b>017716</b>	<b>1.07</b>	<b>CCS</b>	Spare Parts and Maintenance Materials	F				
<b>028213</b>			<b>ASBESTOS ABATEMENT</b>					
<b>028213</b>	<b>2.01</b>	<b>PD</b>	Disposal Bags	D				
<b>028213</b>	<b>2.03</b>	<b>PD</b>	Glove Bags	D				
<b>028213</b>	<b>2.04</b>	<b>PD</b>	Negative Air Pressure Units	D				
<b>028213</b>	<b>2.06</b>	<b>PD</b>	Respirators	D				
<b>028213</b>	<b>2.07</b>	<b>PD</b>	Vacuum Cleaners	D				
<b>028213</b>	<b>1.07.B.1</b>	<b>QCS</b>	Asbestos Site Specific Variance Submittals; if a site specific variance is sought submit the following: One copy of the completed DOSH-751 and DOSH-465 forms	D				
<b>028213</b>	<b>1.07.B.2</b>	<b>QCS</b>	Asbestos Site Specific Variance Submittals; if a site specific variance is sought submit the following: One copy of the New York State Department of Labor site specific variance decision.	D				
<b>028213</b>	<b>1.07.C.1</b>	<b>QCS</b>	Notification Compliance Data	D				
<b>028213</b>	<b>1.07.C.4</b>	<b>QCS</b>	Work Plan	D				
<b>028213</b>	<b>1.07.C.2</b>	<b>QCS</b>	Abatement Contractor's Qualifications Data	D				
<b>028213</b>	<b>1.07.C.3</b>	<b>QCS</b>	Abatement Worker's Qualifications Data	D				
<b>028213</b>	<b>1.07.C.5</b>	<b>QCS</b>	Waste Transporter Permit	D				
<b>028213</b>	<b>1.07.C.6</b>	<b>QCS</b>	Landfill Permit	D				
<b>028213</b>	<b>1.07.D.1</b>	<b>CCS</b>	Waste Shipment Records and Disposal Site Receipts	F				

# SCHEDULE OF SUBMITTALS

**PROJECT NO.: 47599 - C**

SUBMITTALS FOR APPROVAL				Send to:	Critical Submittals	Contractor's Projected Dates Allow at least 4 weeks for Approval (allows time for any resubmission)		
Spec Section	Sub Section	Type	Description	F F/O D S	Mark "X" for all that apply	Projected Transmittal Date:	Projected Approval Date:	Projected Delivery Date:
028213	1.07.E.1	CCS	Daily Log	F				
028213	1.07.E.2	CCS	Air Monitoring Data	F				
<b>028304</b>								
<b>HANDLING OF LEAD CONTAINING MATERIALS</b>								
028304	1.06.A.2	QCS	Work Plan	D				
028304	1.06.A.1	QCS	Lad Handling Worker's Qualifications Data	D				
028304	1.06.A.3	QCS	Waste Transporter Permit	D				
028304	1.06.C.2	CCS	Disposal Site Receipts	F				
<b>030131</b>								
<b>CONCRETE REHABILITATION</b>								
030131	2.02.B.1	PD	Cement/Acrylic/Latex Base Patching Mortar Type C-1	D				
030131	2.02.B.2	PD	Cement/Acrylic/Latex Base Patching Mortar Type C-2	D				
030131	2.02.C	PD	Rebar Coating	D				
030131	2.02.D	PD	Cleaning Agent, Bonding Agent/Primer, Sealer/Topcoat	D				
030131	2.02.E	PD	Concrete and Bonding Agent	D				
030131	1.02.B	QCS	Step-by-step procedures for concrete rehabilitation for each type of repair	D				
<b>040121</b>								
<b>MASONRY RESTORATION</b>								
040121	2.01.B	PD	Portland Cement	D				
040121	2.01.C	PD	Lime	D				
040121	2.01.D	PD	Mortar Cement	D				
040121	2.01.E	PD	Sand	D				
040121	2.01.F	PD	Mortar Pigments	D				
040121	2.01.K	PD	Non-Shrink Grout	D				
040121	1.01.B.1	SAM	Mortar for Exposed Joints and Cracks	F				
040121	1.01.B.2	SAM	Masonry Units	F				
040121	1.01.C	QCS	Preconstruction test reports for existing mortar, existing brick, and replacement brick.	D	X			
<b>055000</b>								
<b>METAL FABRICATIONS</b>								
055000	1.02.A	SD	Application to Project: Indicate shop and field welds by standard AWS welding symbols in accordance with AWS A2.4.	D				
055000	2.01.D	PD	Anchors	D				
055000	2.01.F	PD	Bedding Mortar	D				
055000	1.02.B	EPD	Environmental Product Declaration	D				
<b>070150</b>								
<b>MODIFICATIONS TO EXISTING WARRANTIED ROOF SYSTEM</b>								
070150	1.03.B	PACK	Submit the product data and quality control submittals specified below at the same time in one complete package	D				
<b>071900</b>								
<b>WATER REPELLENT COATING</b>								
071900	2.02.A.2	PD	Type 1 Water Repellent	D				
071900	1.02.B	SAM	Type 1 Water Repellent	F				
<b>075323</b>								
<b>ADHERED EPDM ROOFING SYSTEM</b>								

# SCHEDULE OF SUBMITTALS

**PROJECT NO.: 47599 - C**


SUBMITTALS FOR APPROVAL				Send to:	Critical Submittals	Contractor's Projected Dates Allow at least 4 weeks for Approval (allows time for any resubmission)		
Spec Section	Sub Section	Type	Description	F F/O D S	Mark "X" for all that apply	Projected Transmittal Date:	Projected Approval Date:	Projected Delivery Date:
075323	1.04.K	PACK	Submit all items, except contract closeout submittals and SDS, at one time as a complete package.	D				
075323	1.04.G.1	SAM	Sheet Membrane	F				
075323	1.04.G.2	SAM	Sheet Flashing	F				
075323	1.04.G.3	SAM	EPDM Covery Tape	F				
075323	1.04.G.4	SAM	Inseam Tape	F				
075323	1.04.G.5	SAM	Fasteners	F				
075323	1.04.G.6	SAM	Insulation	F				
075323	1.04.G.7	SAM	Coverboard	F				
075323	1.04.G.8	SAM	Underlayment Board	F				
075323	1.04.G.9	SAM	Self-Adhesive Vapor Retarder	F				
075323	1.09.A	CCS	Warranty Extension	F				
075323	1.09.B	CCS	Manufacturer's Warranty	F				
075601			<b>LIQUID APPLIED ROOF COATING SYSTEM</b>					
075601	1.03.A	PACK	Manufacturer's catalog sheets, specifications, and installation instructions for each item specified	D				
075601	1.03.B	QCS	Company Field Advisor	D				
075601	1.03.C.1	CCS	Maintenance Data	F				
075601	1.03.C.2	CCS	Warranty: Copy of specified warranty	F				
076000			<b>FLASHING AND TRIM</b>					
076000	1.04.A	SD	Show the manner of forming, jointing and securing the metal flashings and trim	D				
076000	2.01.A	PD	Prefinished Aluminum Sheet	D				
076000	2.02.A	PD	Nails	D				
076000	2.02.B	PD	Screws, Bolts and other Fastening Accessories	D				
076000	2.02.C	PD	Anchors	D				
076000	1.04.C.1	SAM	Materials for Flashings	F				
076000	1.04.C.2	SAM	Anchors	F				
076000	1.04.C.3	SAM	Cap Flashings	F				
076000	1.04.C.4	SAM	Coping	F				
077123			<b>GUTTERS AND DOWNSPOUTS (Commercial Type)</b>					
077123	2.01.B	PD	Sealant	D				
077123	2.03	PD	Splash Pad	D				
077123	1.02.C	SD	Shop Drawings: Show method of forming, jointing, and securing the gutters and downspouts. Include attachment to adjoining construction	D				
077123	1.02.B.1	SAM	Gutter	F				
077123	1.02.B.2	SAM	Downspout	F				
077123	1.02.B.3	SAM	Hanger Brackets, Braces, and Stiffeners	F				
077123	1.02.B.4	SAM	Fasteners	F				
077123	1.02.B.5	SAM	Color Samples	F				
079200			<b>JOINT SEALERS</b>					
079200	2.01.A	PD	Type 1 Sealant	D				
079200	2.01.B	PD	Type 3 Sealant	D				
079200	2.01.C	PD	Sealant Colors	D				

# SCHEDULE OF SUBMITTALS

**PROJECT NO.: 47599 - C**

SUBMITTALS FOR APPROVAL				Send to:	Critical Submittals	Contractor's Projected Dates Allow at least 4 weeks for Approval (allows time for any resubmission)		
Spec Section	Sub Section	Type	Description	F F/O D S	Mark "X" for all that apply	Projected Transmittal Date:	Projected Approval Date:	Projected Delivery Date:
079200	2.02.A	PD	Fire Barrier System for Expansion Joint	D				
079200	2.03.A	PD	Joint Primer/Sealer/Conditioner	D				
079200	2.03.B	PD	Backer Rod	D				
079200	2.03.C	PD	Cleaning Solvents	D				
079200	1.01.C.1	SAM	Sealant	F				
079200	1.01.C.2	SAM	Joint Primer/Sealer/Conditions	F				
079200	1.01.C.3	SAM	Backer Rods	F				
092300			<b>PLASTERING</b>					
092300	2.01	PD	Lime-Portland Cement Stucco Materials	D				
092300	2.02.B	PD	Bonding Compound	D				
092300	2.03.A	PD	Corner Beads	D				
092300	2.03.B	PD	Casing Beads	D				
092300	2.03.C	PD	Base Screeds	D				
092300	2.03.CD	PD	Expanded Metal Reinforcement	D				
092300	1.01.B.1	QCS	Sand	D				

CONSULTANT  
CERTIFICATE OF AUTHORIZATION No.: 0019551

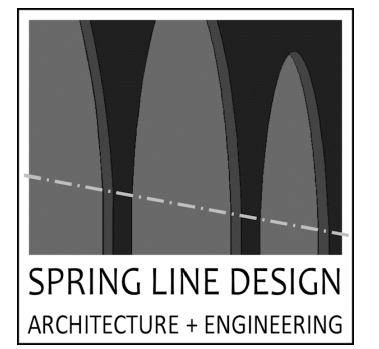

**ENERGY CODE STATEMENT:**  
TO THE BEST OF THE REGISTERED DESIGN PROFESSIONAL'S KNOWLEDGE, BELIEF AND PROFESSIONAL JUDGEMENT, THESE PLANS AND/OR SPECIFICATIONS ARE IN COMPLIANCE WITH THE 2020 ENERGY CODE.

**UNIFORM CODE STATEMENT:**  
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**WARNING:**  
THE ALTERATION OF THIS MATERIAL IN ANY WAY, UNLESS DONE UNDER THE DIRECTION OF A COMPARABLE PROFESSIONAL, I.E. ARCHITECT FOR AN ARCHITECT, ENGINEER FOR AN ENGINEER OR LANDSCAPE ARCHITECT FOR LANDSCAPE ARCHITECT, IS A VIOLATION OF THE NEW YORK STATE EDUCATION LAW AND/OR REGULATIONS AND A CLASS 'A' MISDEMEANOR.





CONTRACT: **CONSTRUCTION**  
TITLE: REPAIR ROOF STATE ARMOY  
LOCATION: BUILDING No. 71 321 MANOR ROAD STATEN ISLAND, NY  
CLIENT: DIVISION OF MILITARY AND NAVAL AFFAIRS

**REVISED DRAWING 08/28/2024**

MARK	DATE	DESCRIPTION
▲	08/28/2024	ADDENDUM 4
	05/24/2024	BID DOCUMENT

PROJECT NUMBER: **47599 - C**  
DESIGNED BY: KK  
DRAWN BY: SS  
FIELD CHECK:  
APPROVED:  
SHEET TITLE: **PARTIAL ROOF REMOVAL PLAN**  
DRAWING NUMBER: **A-011**  
SHEET 7 OF 20

**ALTERNATE No. 1**

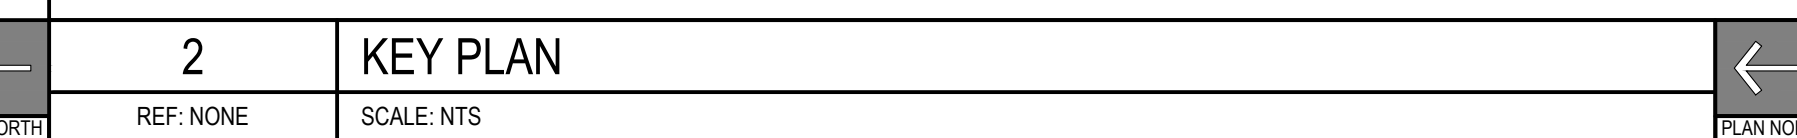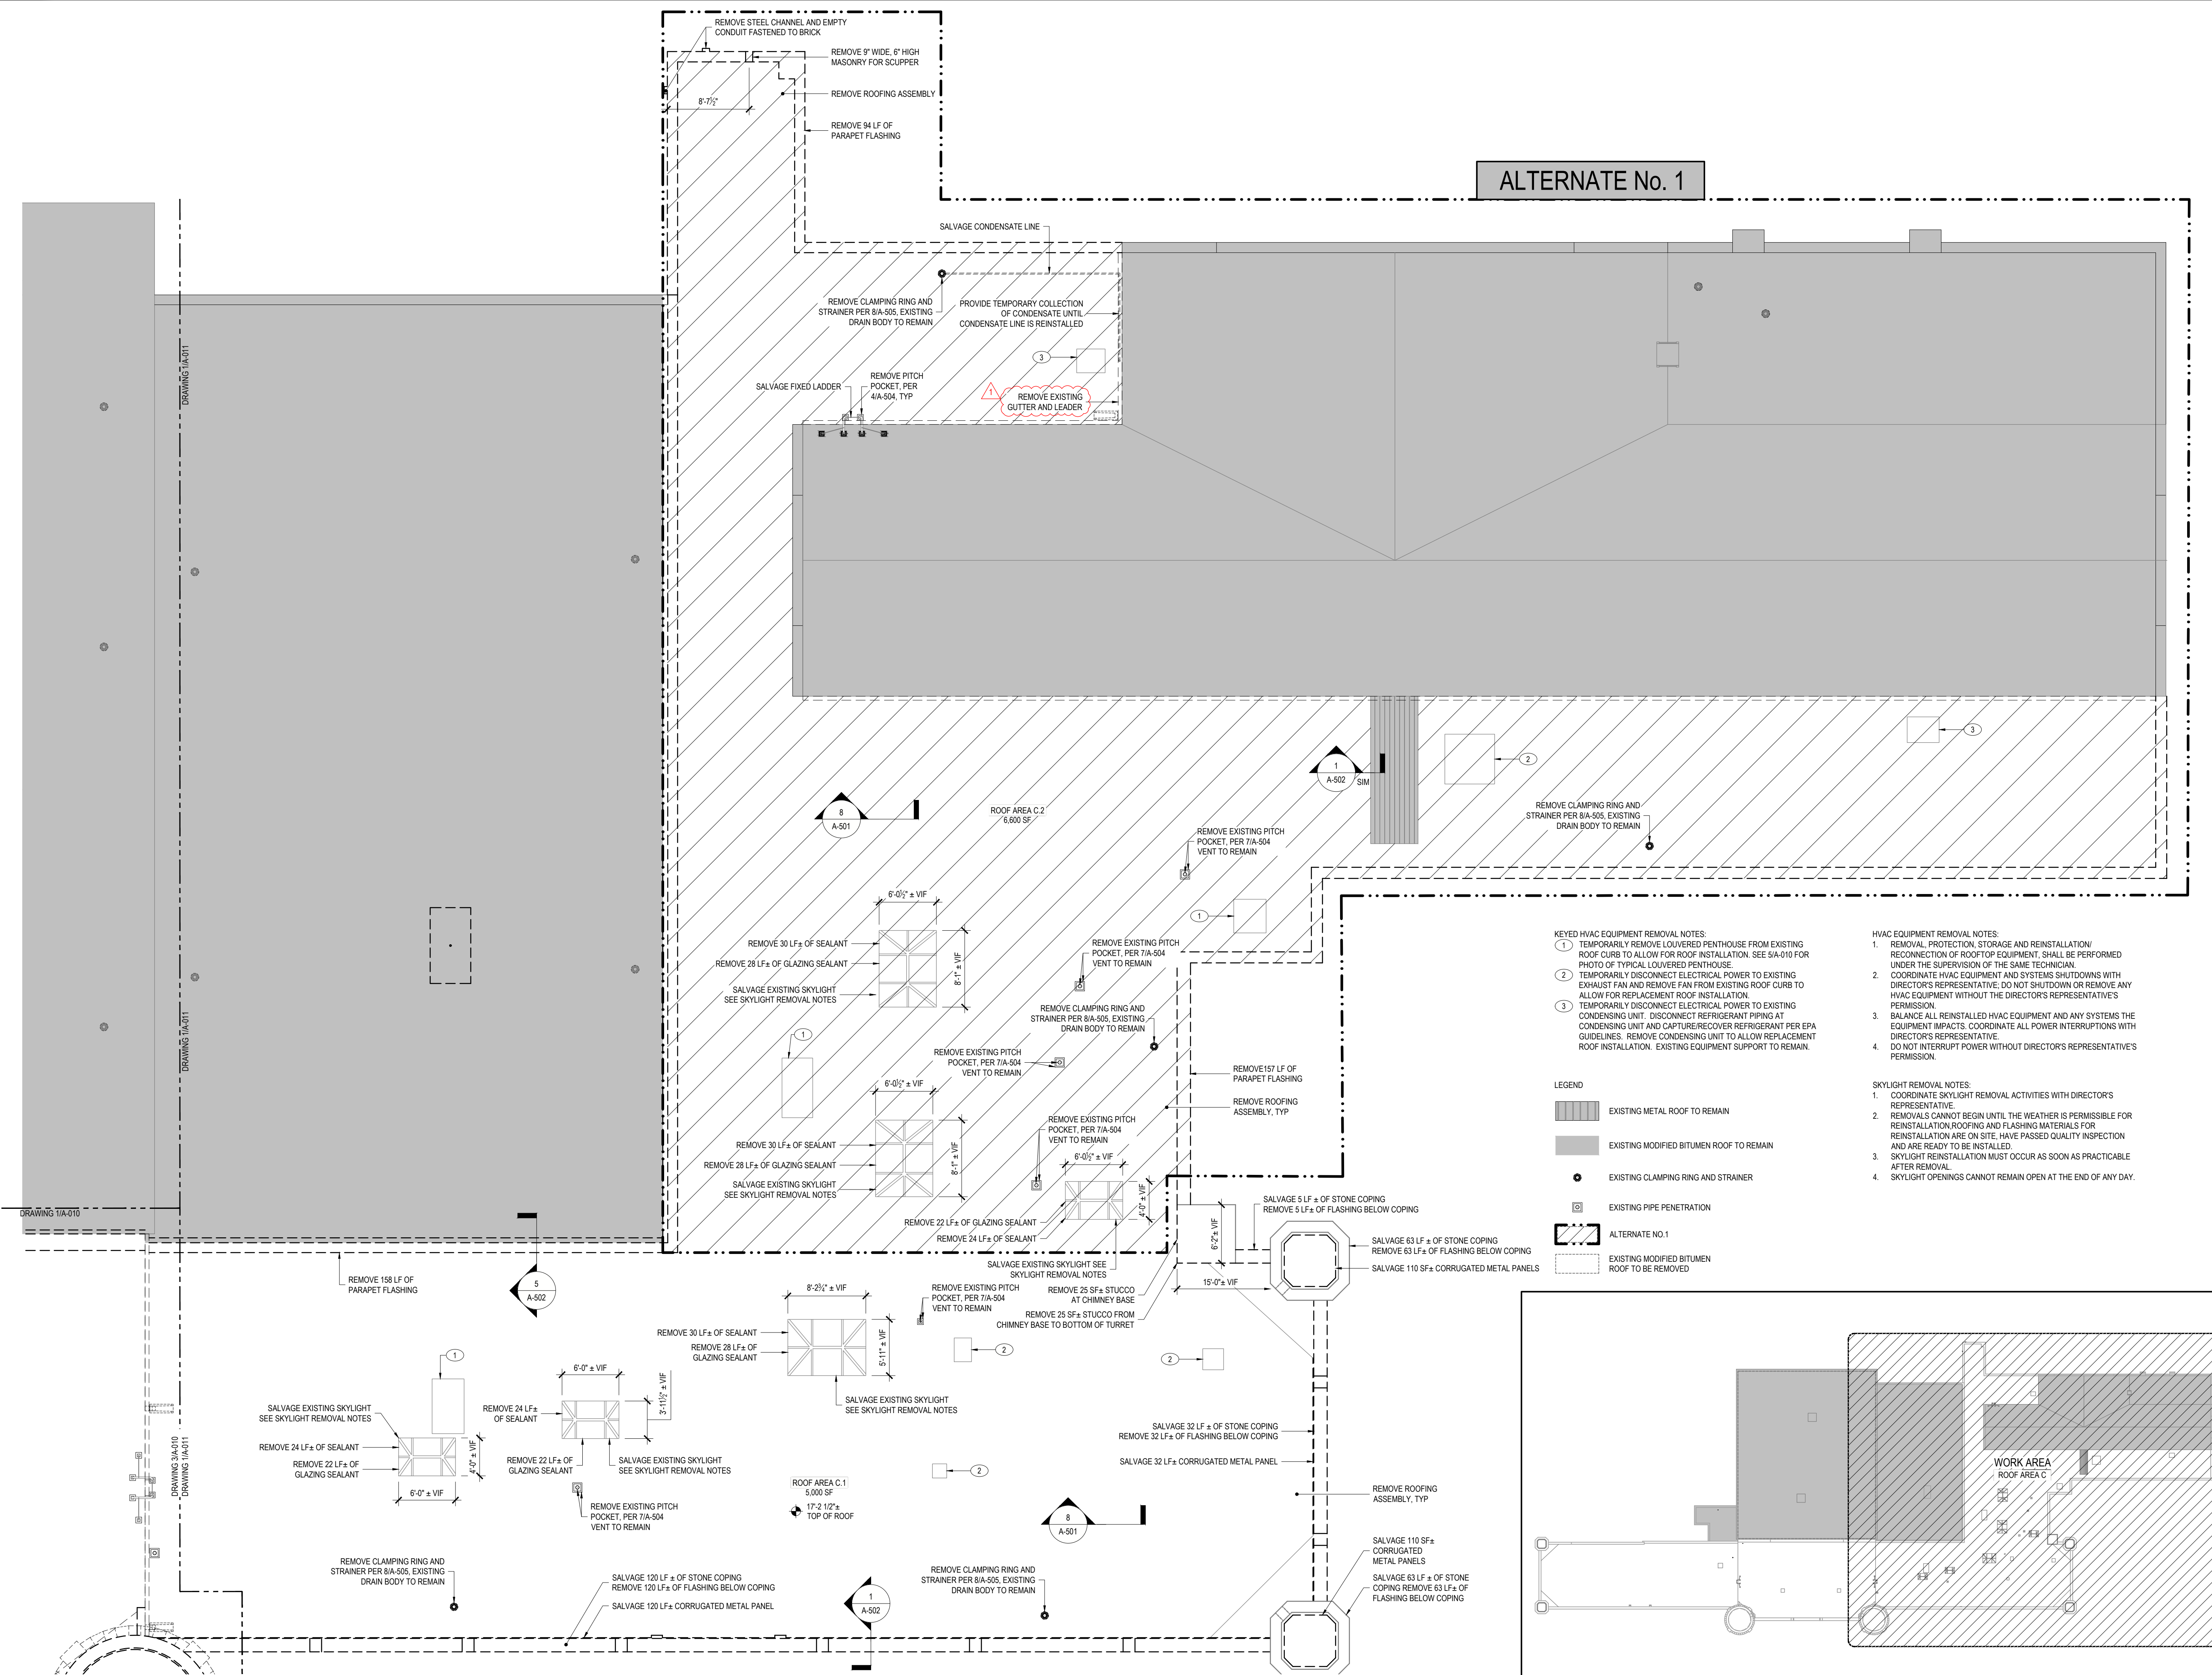


**1 ROOF AREA C REMOVAL PLAN**  
REF: 21A-011 SCALE: 1/8" = 1'-0"

**2 KEY PLAN**  
REF: NONE SCALE: NTS

36x24 PLOT SHEET



CONSULTANT  
CERTIFICATE OF AUTHORIZATION No.: 0019551

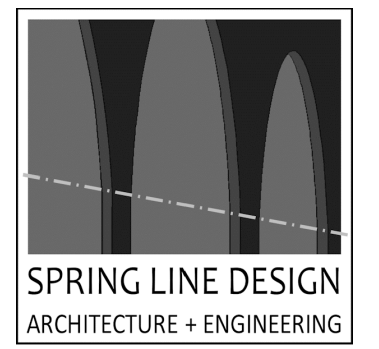

**ENERGY CODE STATEMENT:**  
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**UNIFORM CODE STATEMENT:**  
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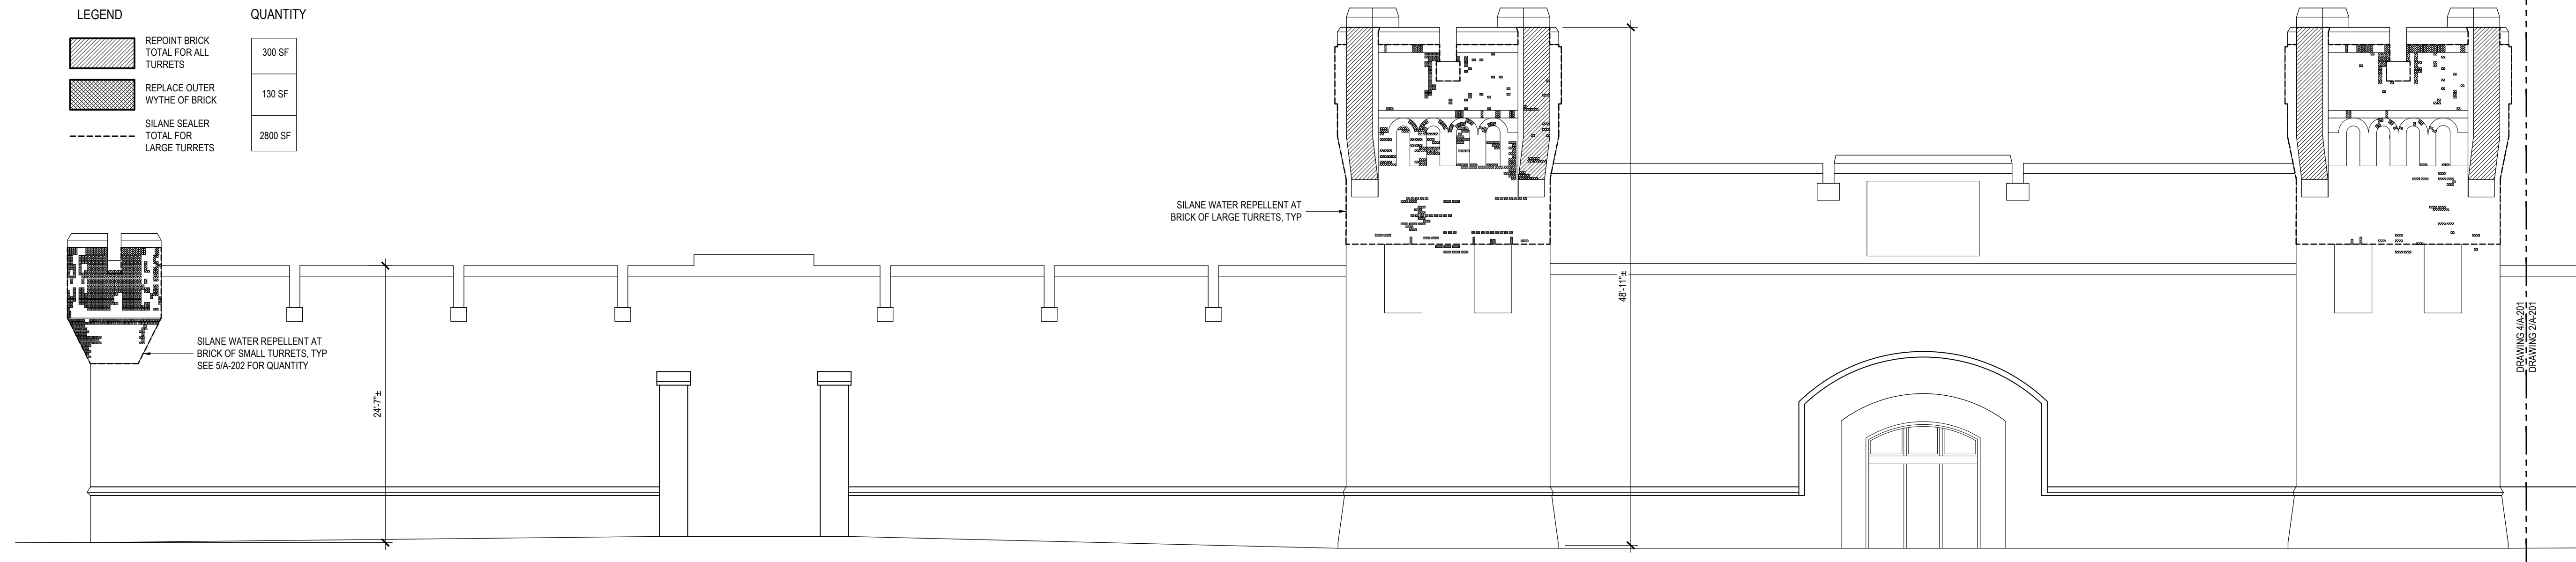
**CONSTRUCTION**  
TITLE: REPAIR ROOF STATE ARMY  
LOCATION: BUILDING No. 71  
321 MANOR ROAD  
STATEN ISLAND, NY  
CLIENT: DIVISION OF MILITARY AND NAVAL AFFAIRS

**REVISED DRAWING 08/28/2024**


MARK	DATE	DESCRIPTION
△	08/28/2024	ADDENDUM 4
	05/24/2024	BID DOCUMENT

PROJECT NUMBER: **47599 - C**  
DESIGNED BY: KK  
DRAWN BY: SS  
FIELD CHECK:  
APPROVED:


SHEET TITLE:  
**ELEVATIONS**  
DRAWING NUMBER:  
**A-201**  
SHEET 11 OF 20




**4 WEST ELEVATION**  
REF: 1/A-101 SCALE: 1/8" = 1'-0"

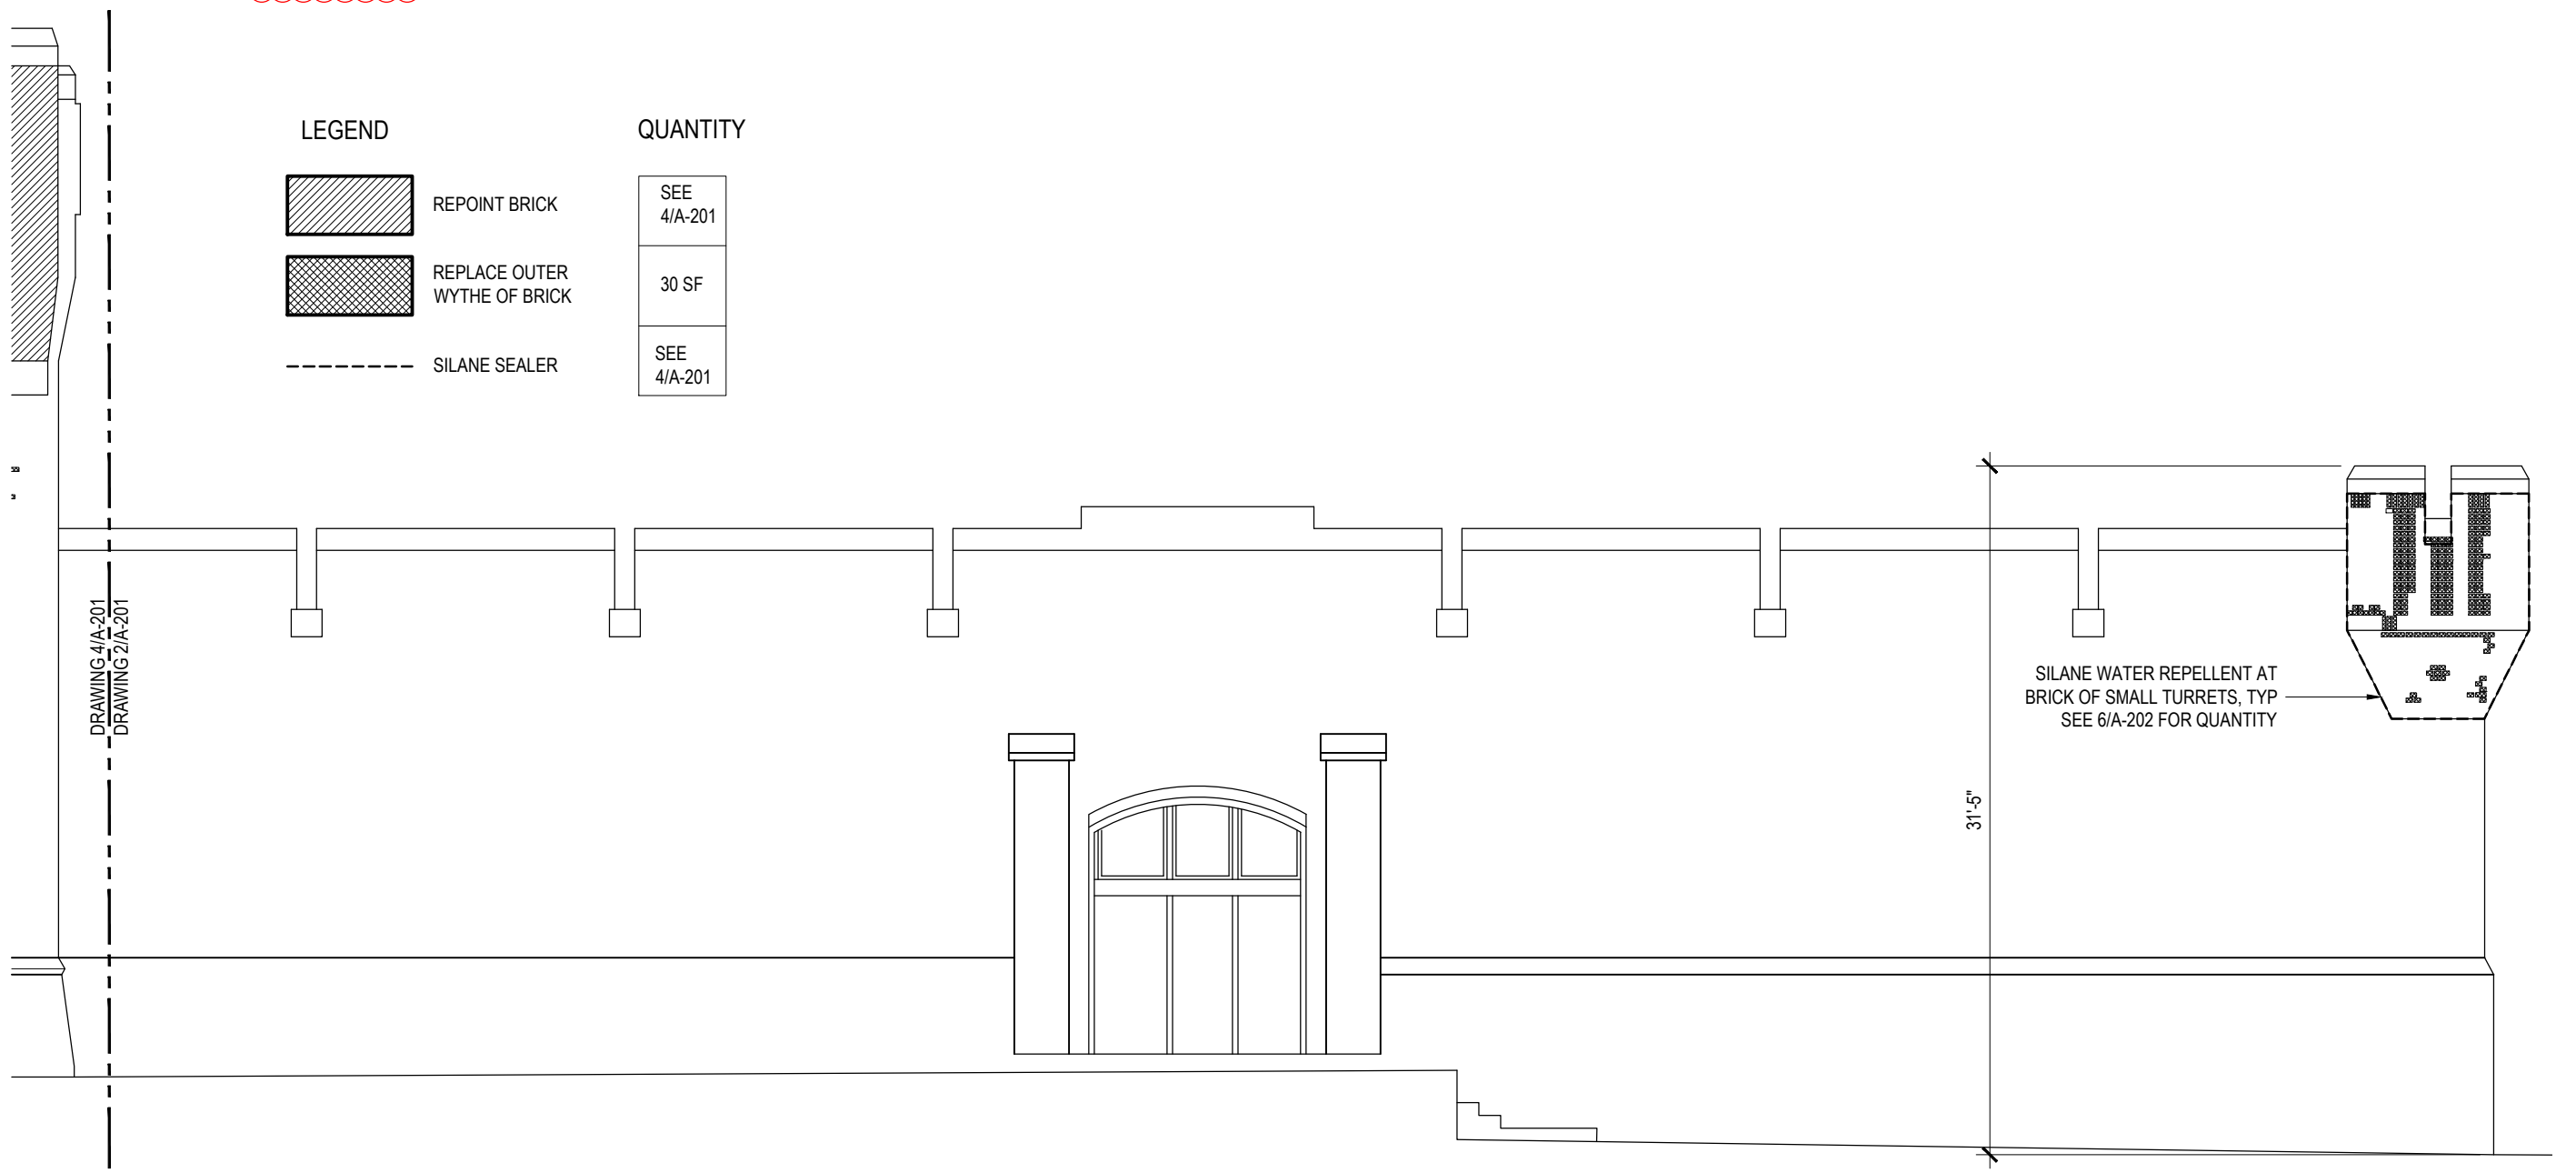

**2 WEST ELEVATION**  
REF: 1/A-102 SCALE: 1/8" = 1'-0"

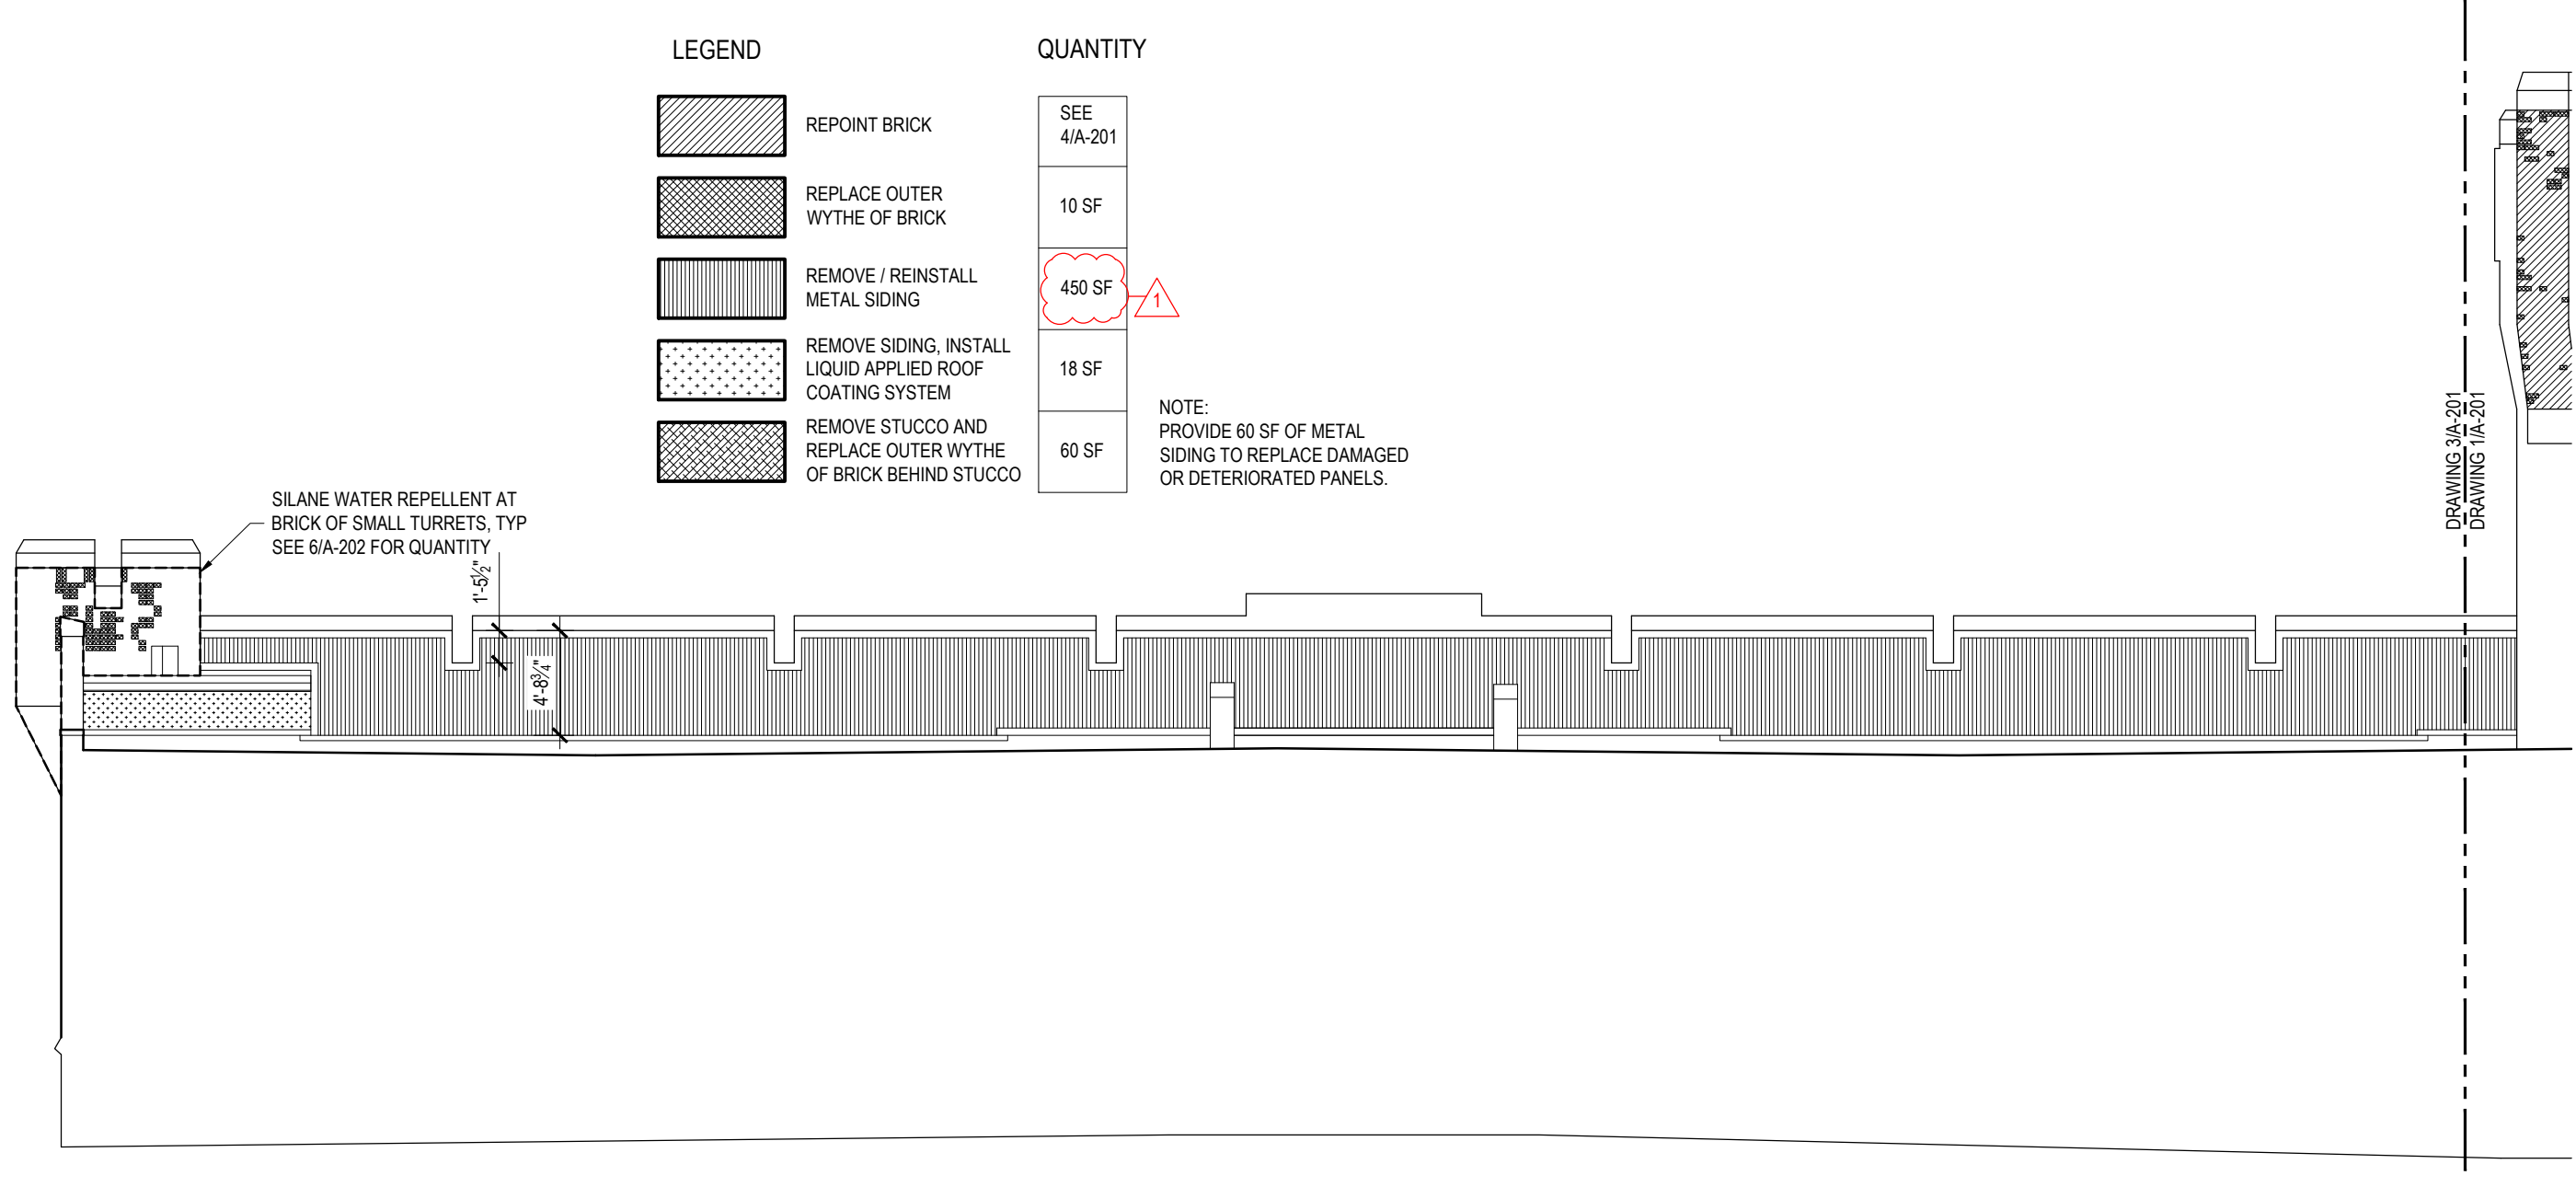

**3 WEST PARAPET VIEWED FROM ROOF**  
REF: 1/A-102 SCALE: 1/8" = 1'-0"

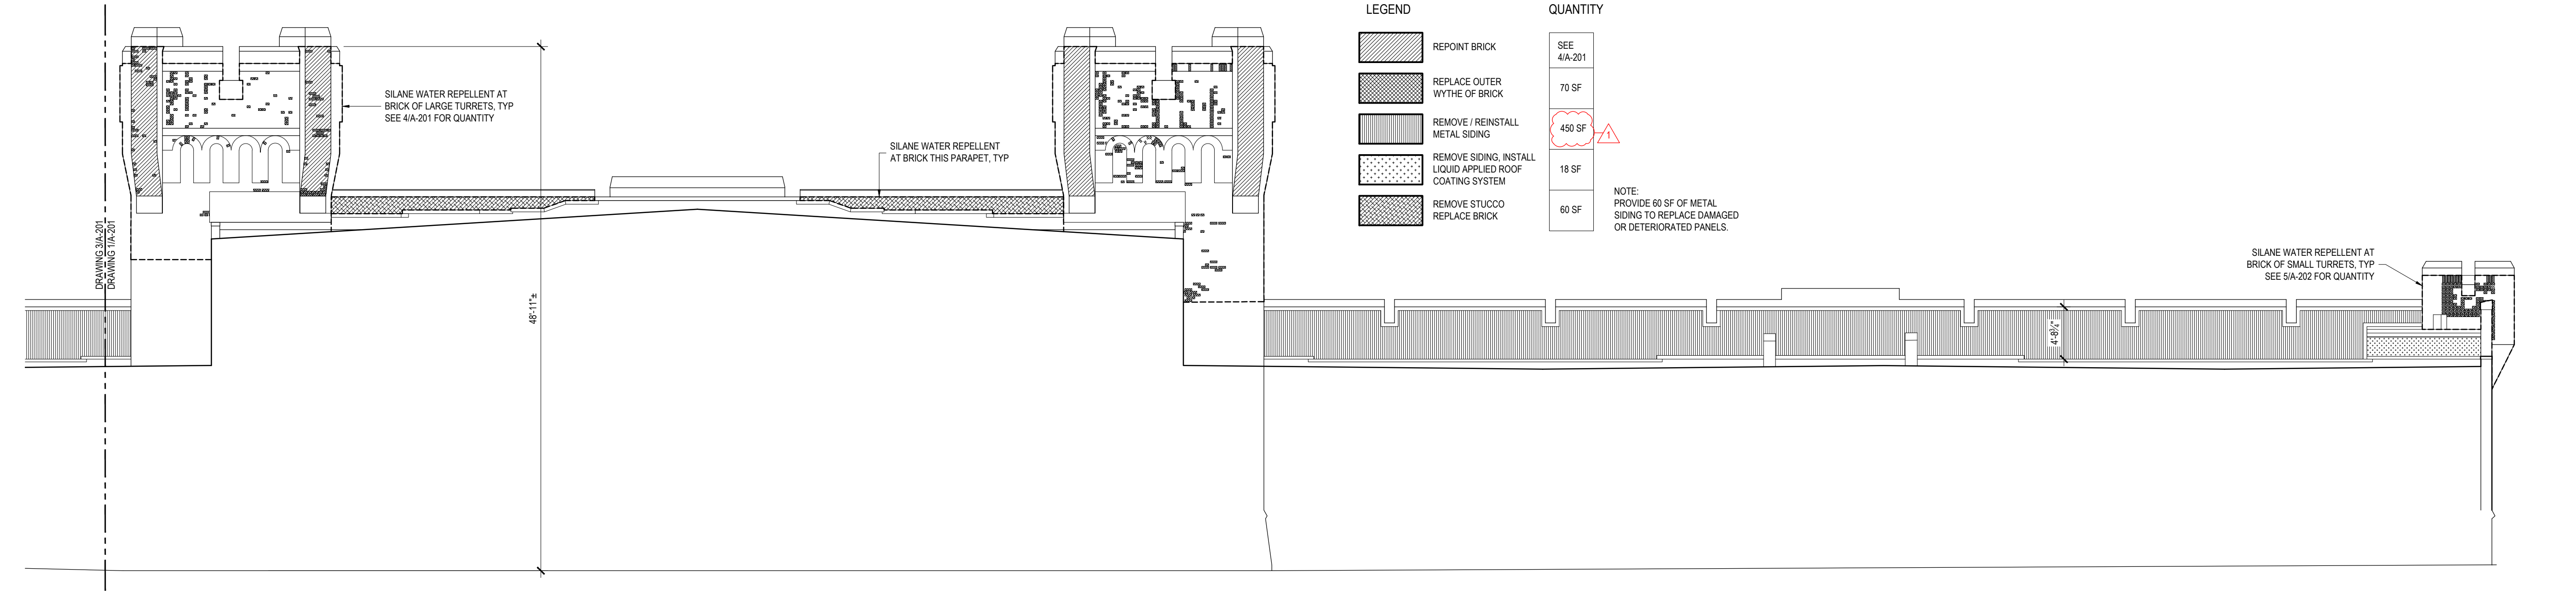

**1 WEST PARAPET VIEWED FROM ROOF**  
REF: 4/A-101 SCALE: 1/8" = 1'-0"

36x24 PLOT SHEET



**ENERGY CODE STATEMENT:**  
TO THE BEST OF THE REGISTERED DESIGN PROFESSIONAL'S KNOWLEDGE, BELIEF AND PROFESSIONAL JUDGEMENT, THESE PLANS AND/OR SPECIFICATIONS ARE IN COMPLIANCE WITH THE 2020 ENERGY CODE.

**UNIFORM CODE STATEMENT:**  
TO THE BEST OF THE REGISTERED DESIGN PROFESSIONAL'S KNOWLEDGE, BELIEF AND PROFESSIONAL JUDGEMENT, THESE PLANS AND/OR SPECIFICATIONS ARE IN COMPLIANCE WITH THE 2020 UNIFORM CODE.

**WARNING:**  
THE ALTERATION OF THIS MATERIAL IN ANY WAY, UNLESS DONE UNDER THE DIRECTION OF A COMPARABLE PROFESSIONAL, I.E. ARCHITECT FOR AN ARCHITECT, ENGINEER FOR AN ENGINEER OR LANDSCAPE ARCHITECT FOR LANDSCAPE ARCHITECT, IS A VIOLATION OF THE NEW YORK STATE EDUCATION LAW AND/OR REGULATIONS AND A CLASS 'A' MISDEMEANOR.

















CONTRACT: **CONSTRUCTION**  
TITLE: REPAIR ROOF STATE ARMYORY  
LOCATION: BUILDING No. 71 321 MANOR ROAD STATEN ISLAND, NY  
CLIENT: DIVISION OF MILITARY AND NAVAL AFFAIRS

**REVISED DRAWING 08/28/2024**

MARK	DATE	DESCRIPTION
△	08/28/2024	ADDENDUM 4
△	08/26/2024	ADDENDUM 3
△	05/24/2024	BID DOCUMENT

PROJECT NUMBER: **47599 - C**  
DESIGNED BY: KK  
DRAWN BY: SS  
FIELD CHECK:  
APPROVED:  
SHEET TITLE: **ELEVATIONS**  
DRAWING NUMBER: **A-202**  
SHEET 12 OF 20

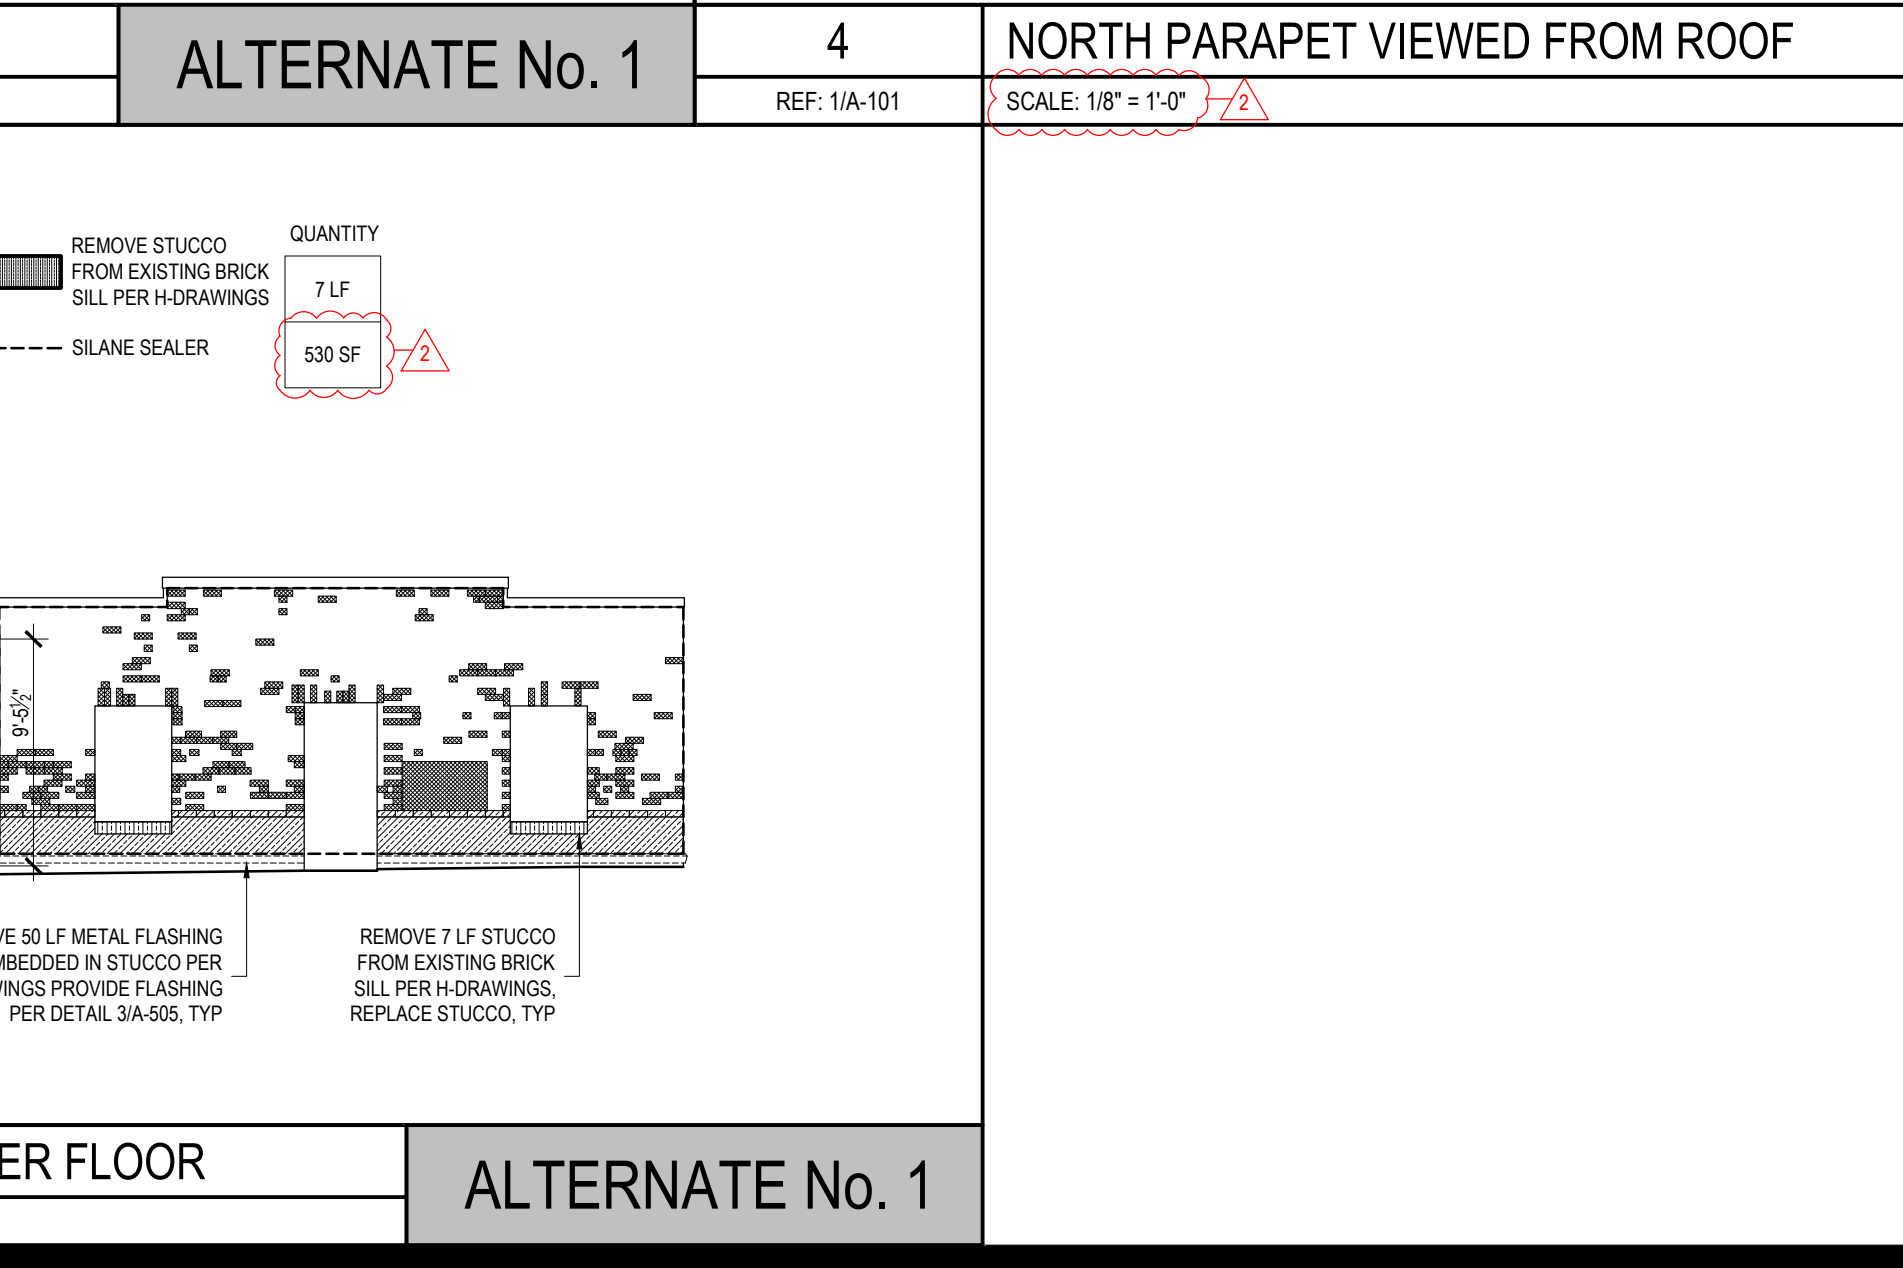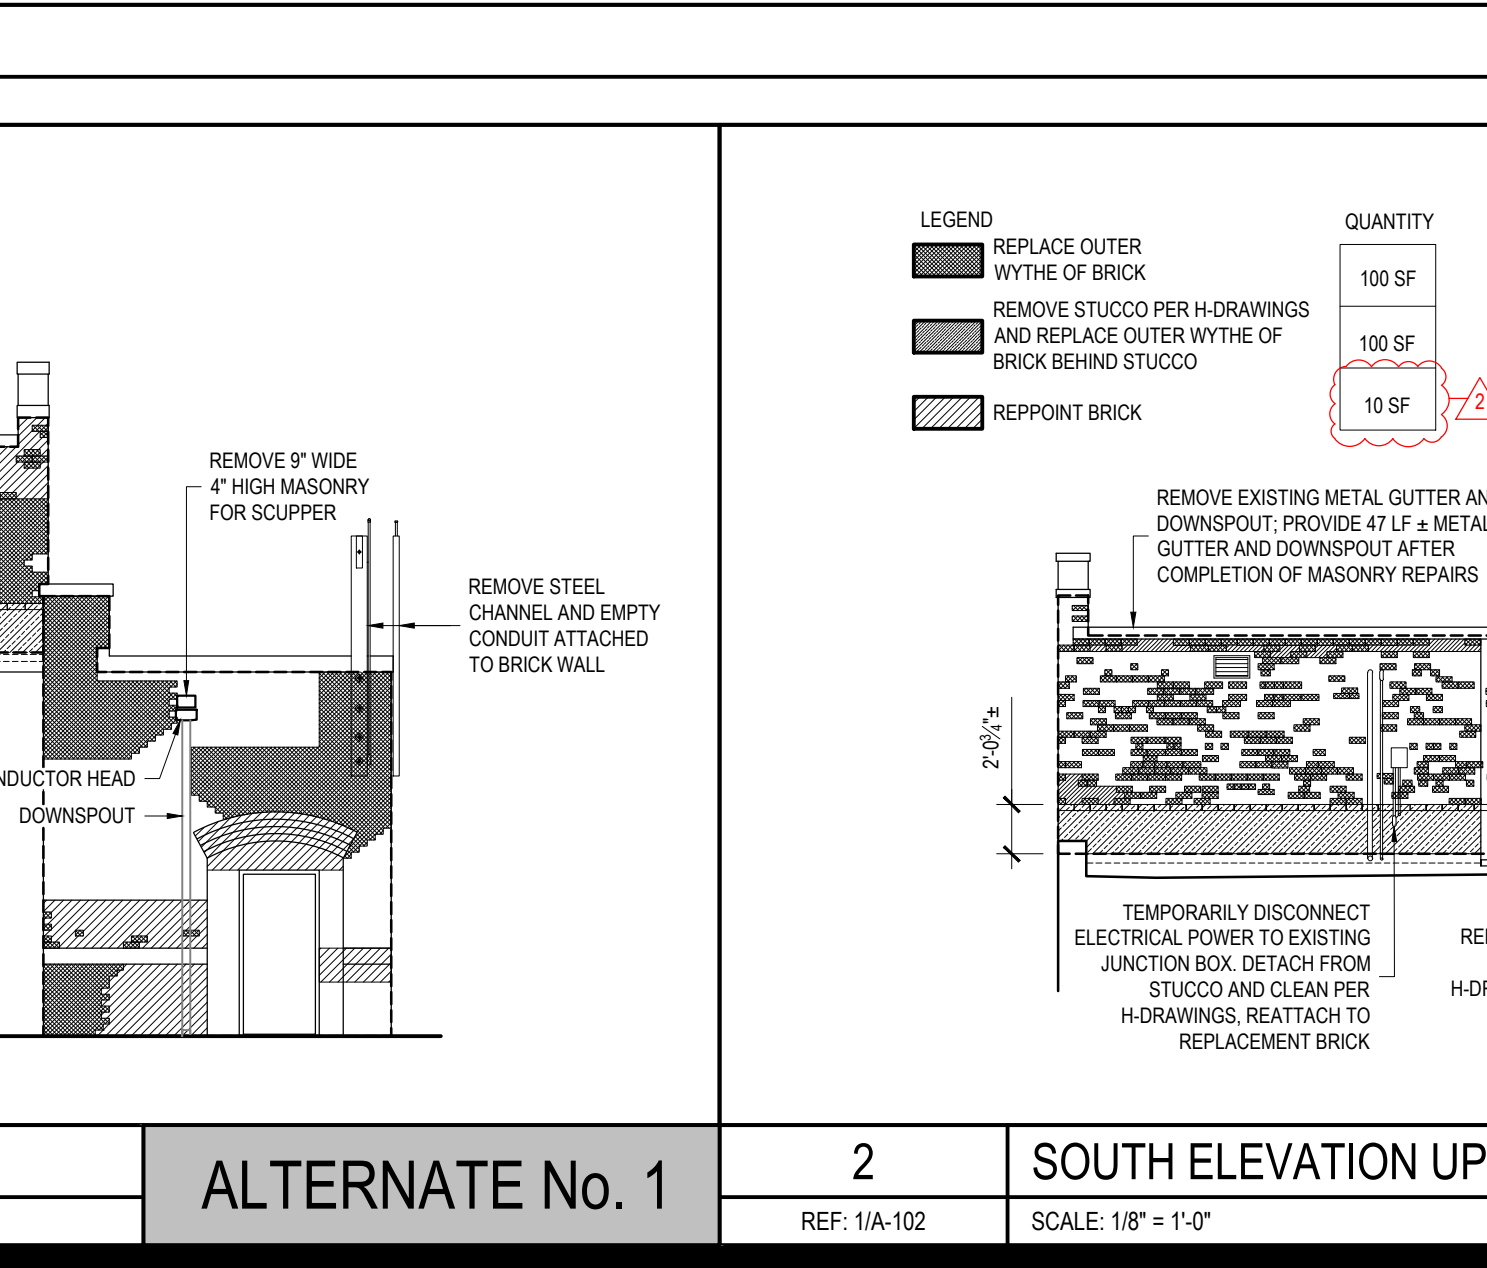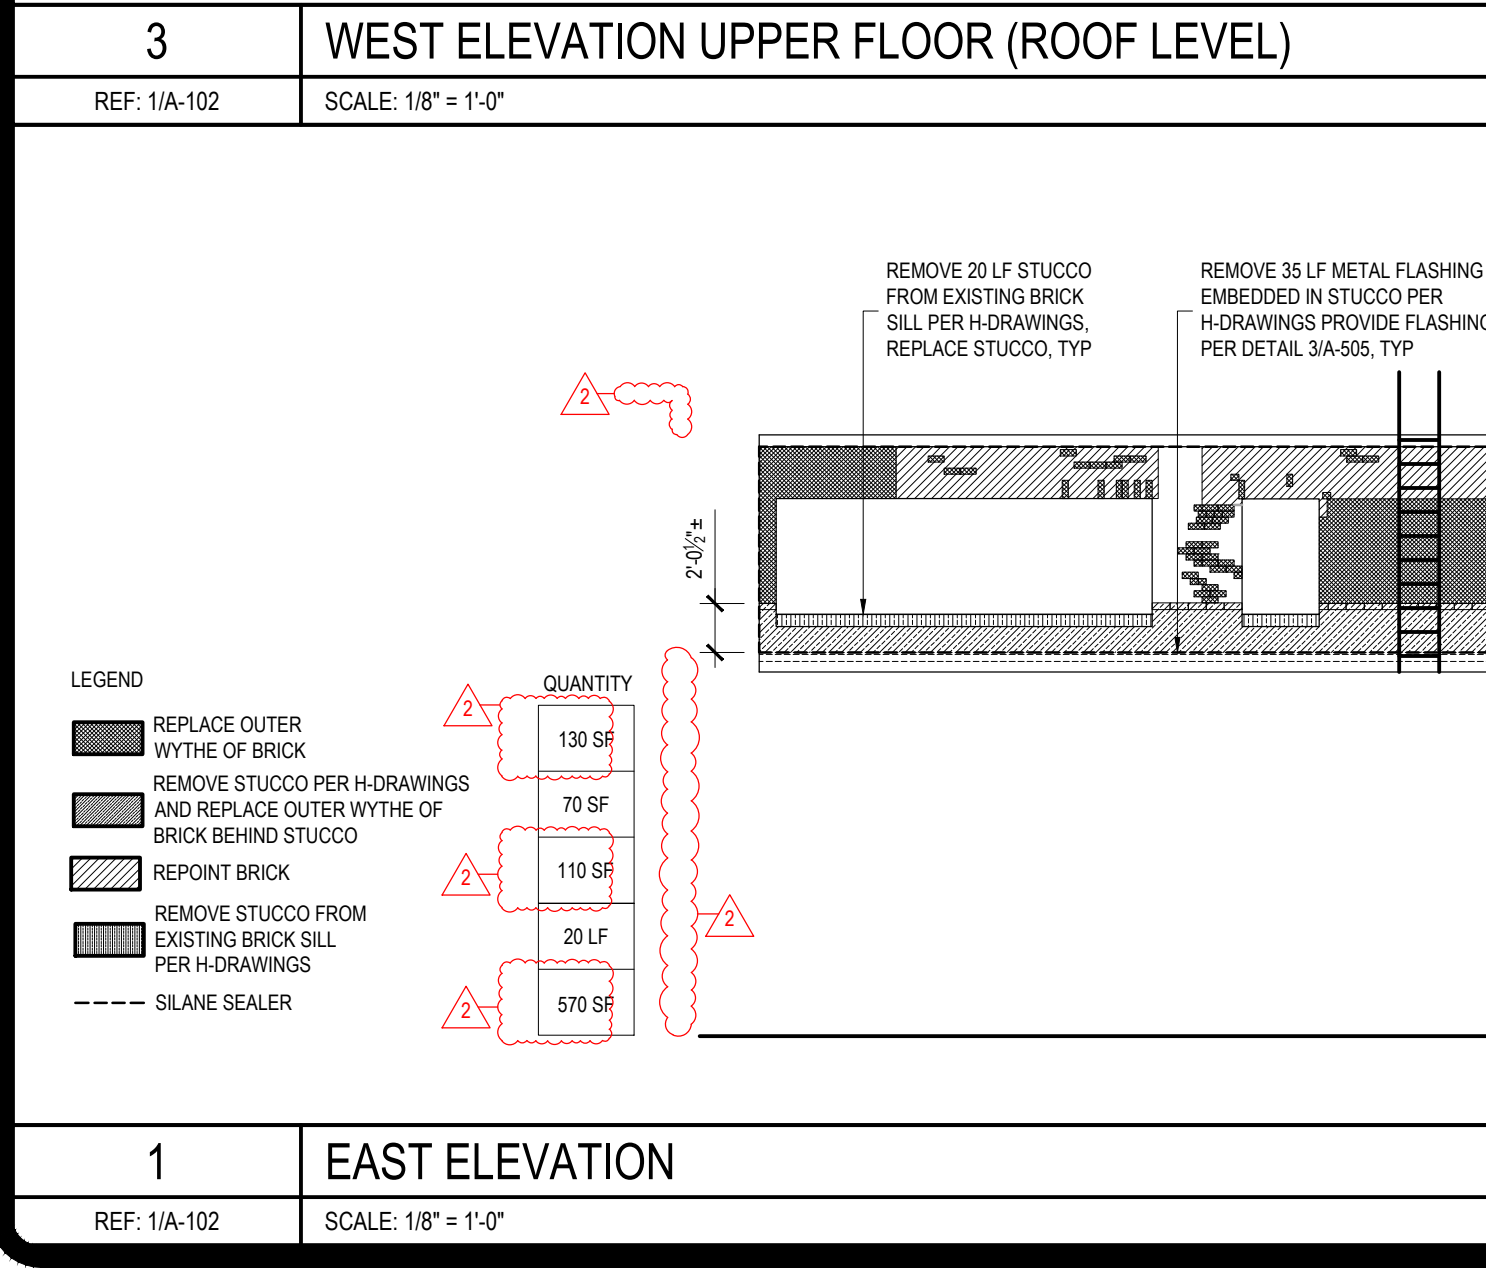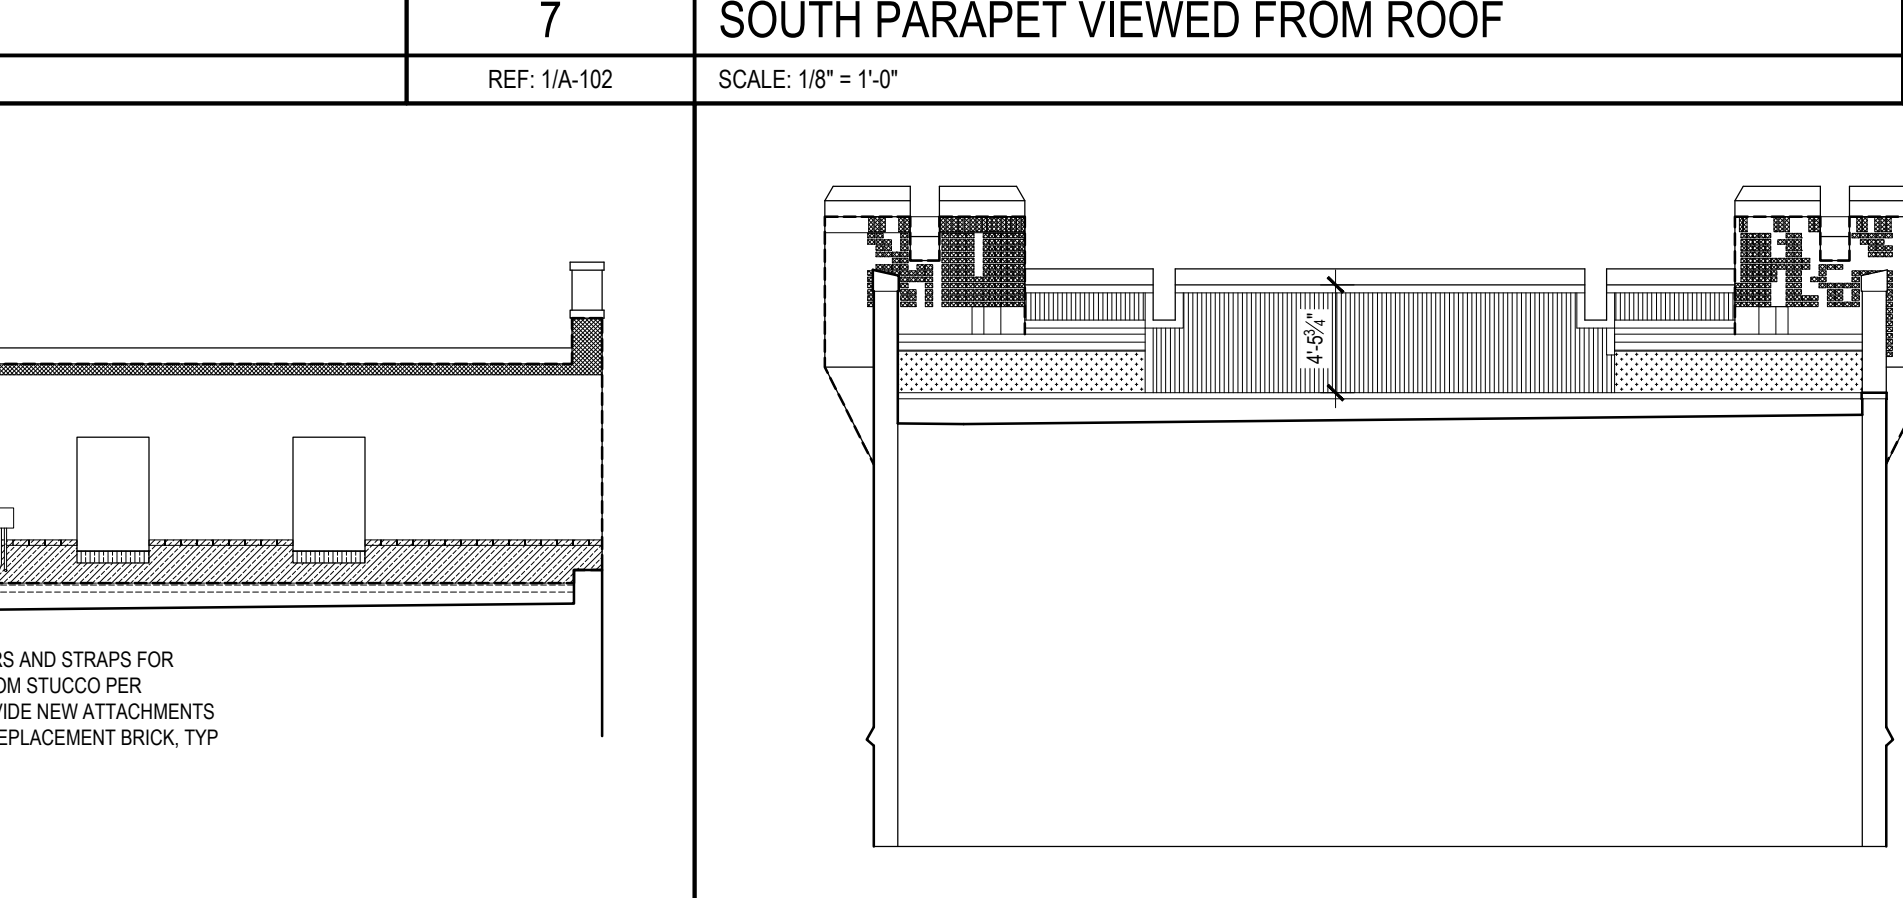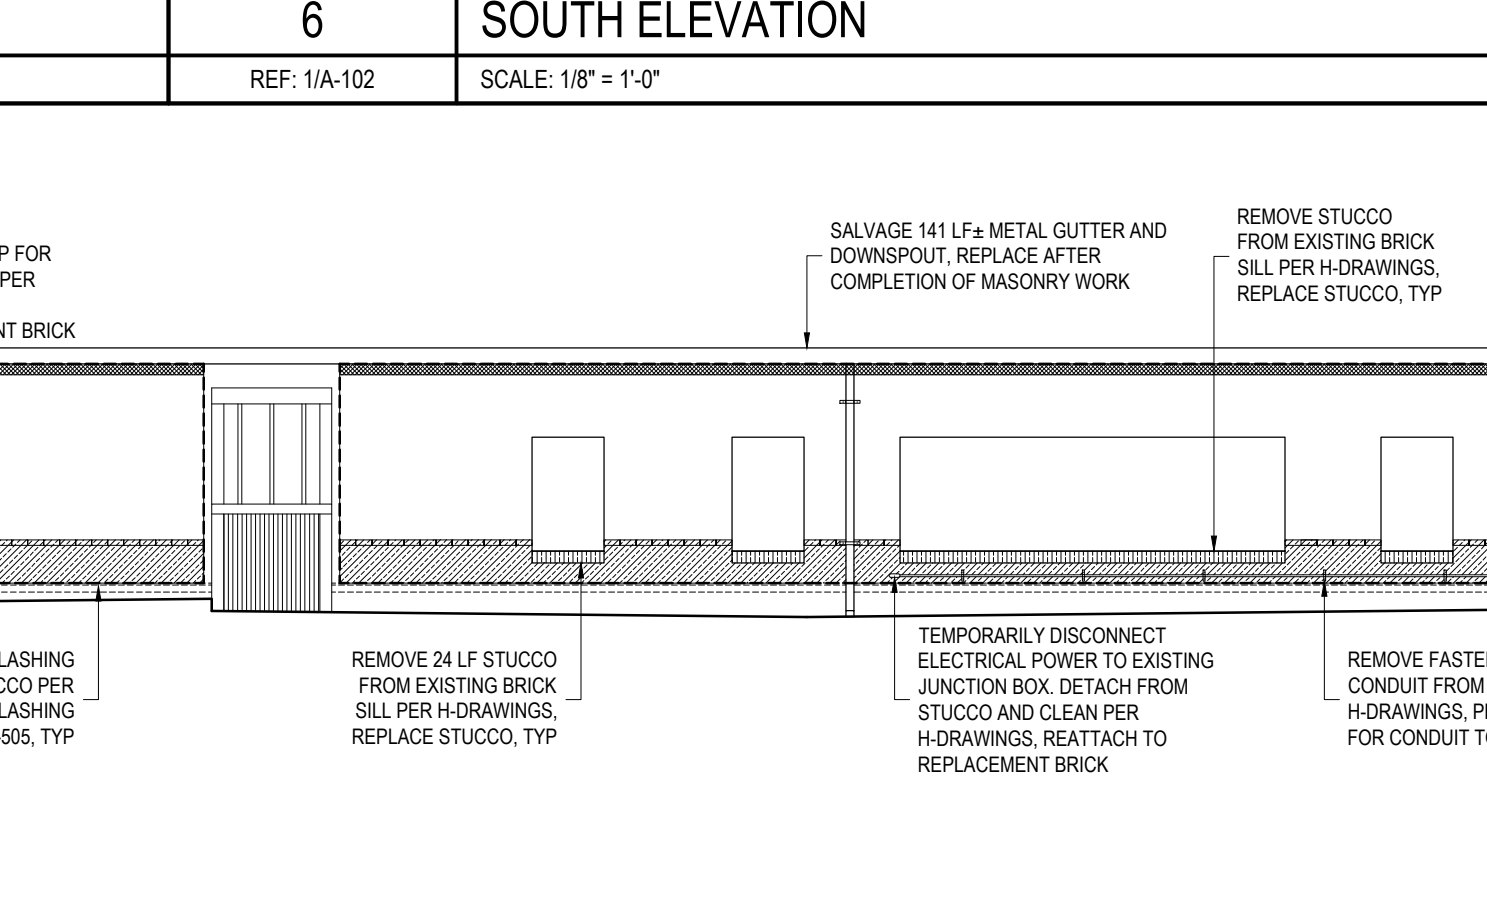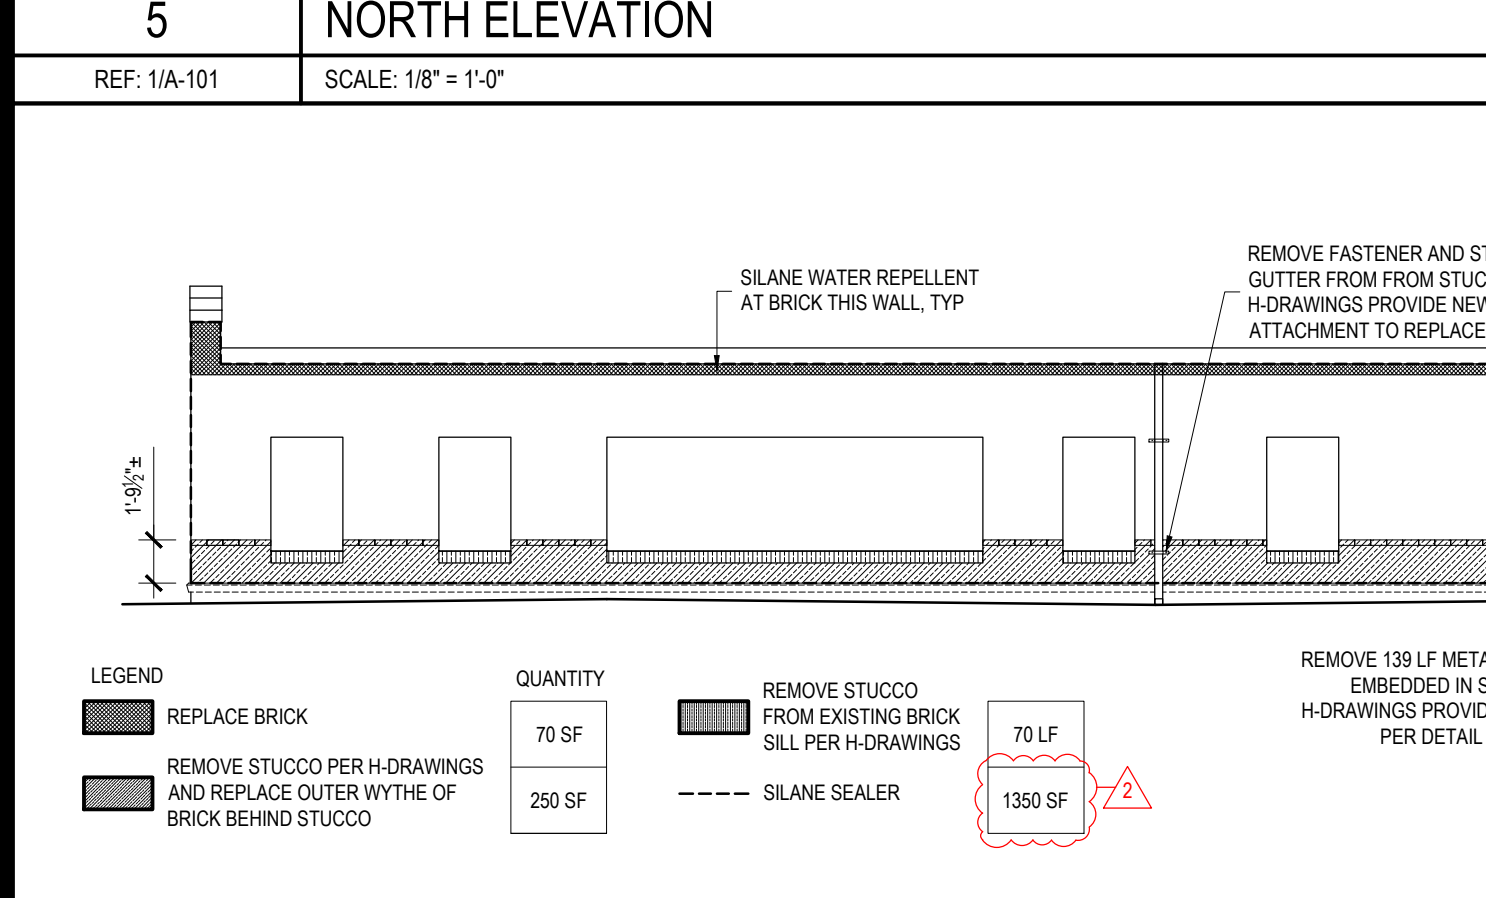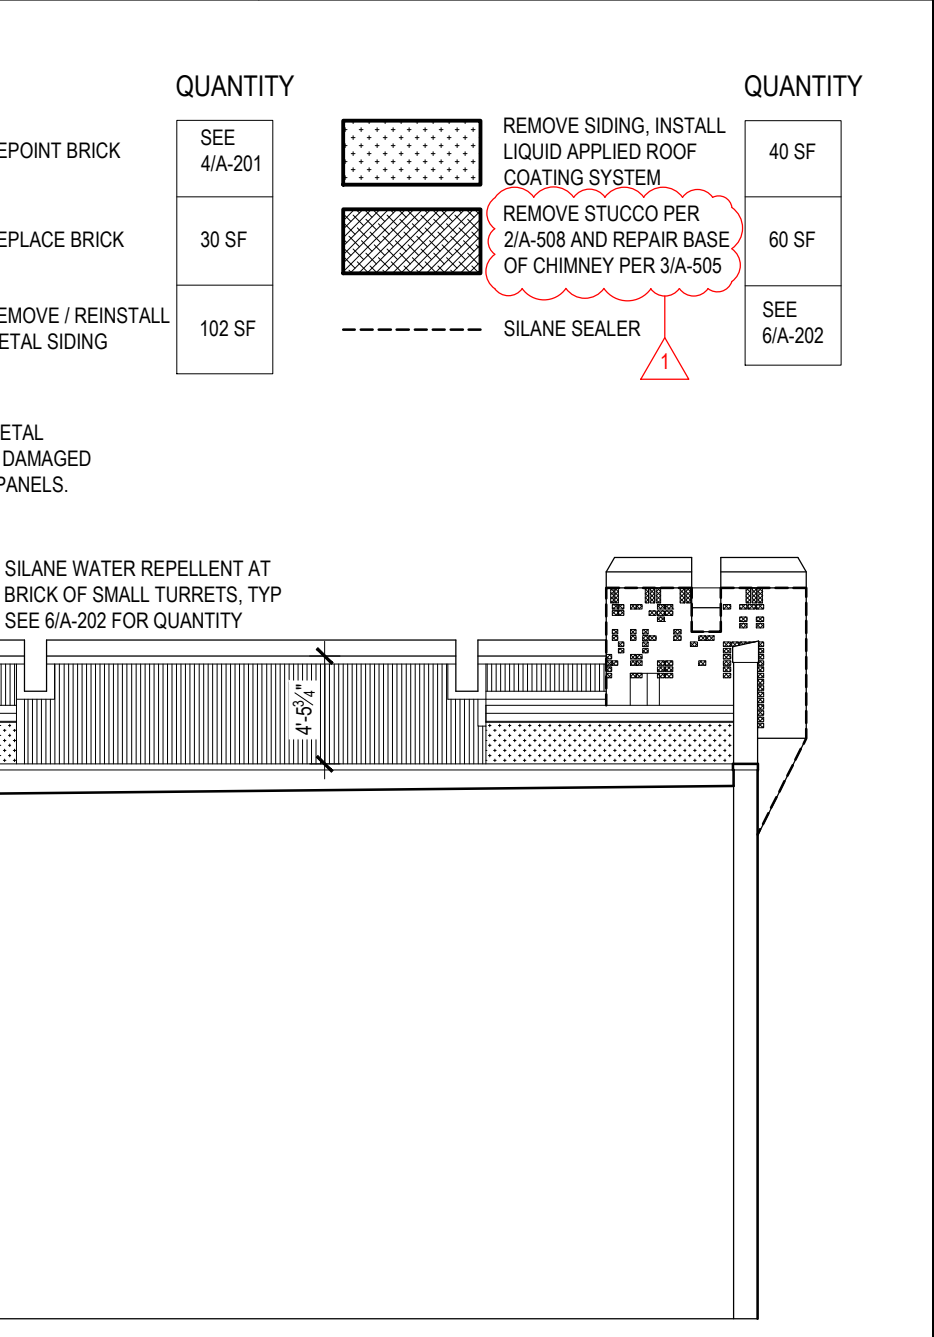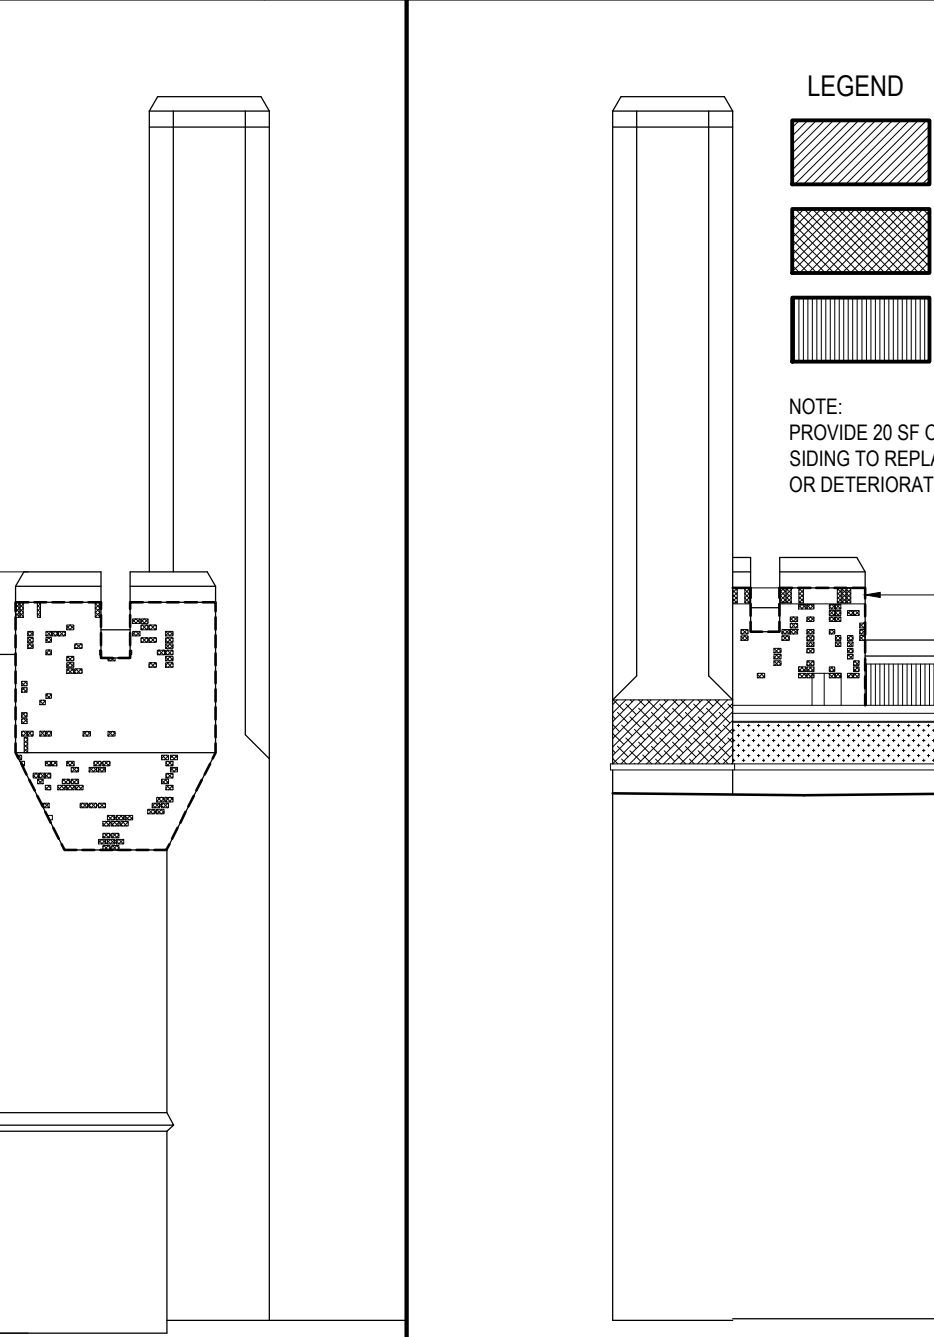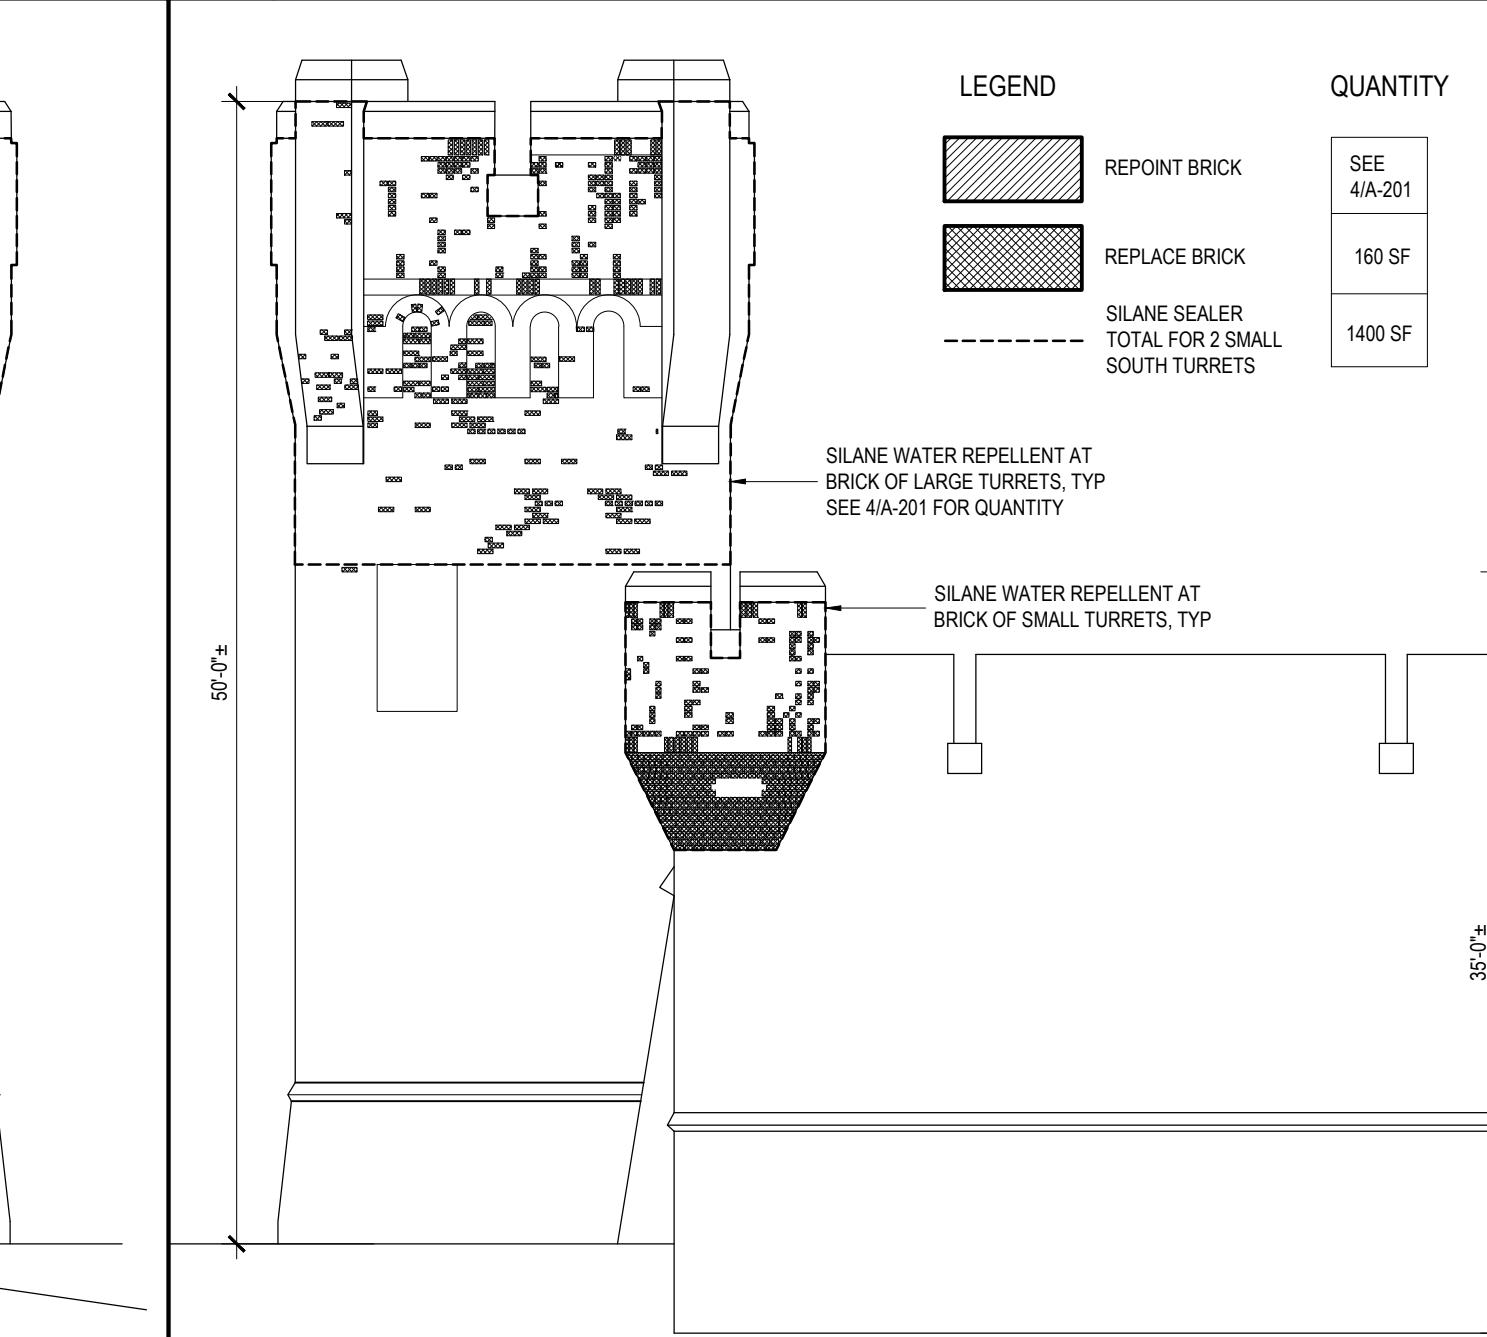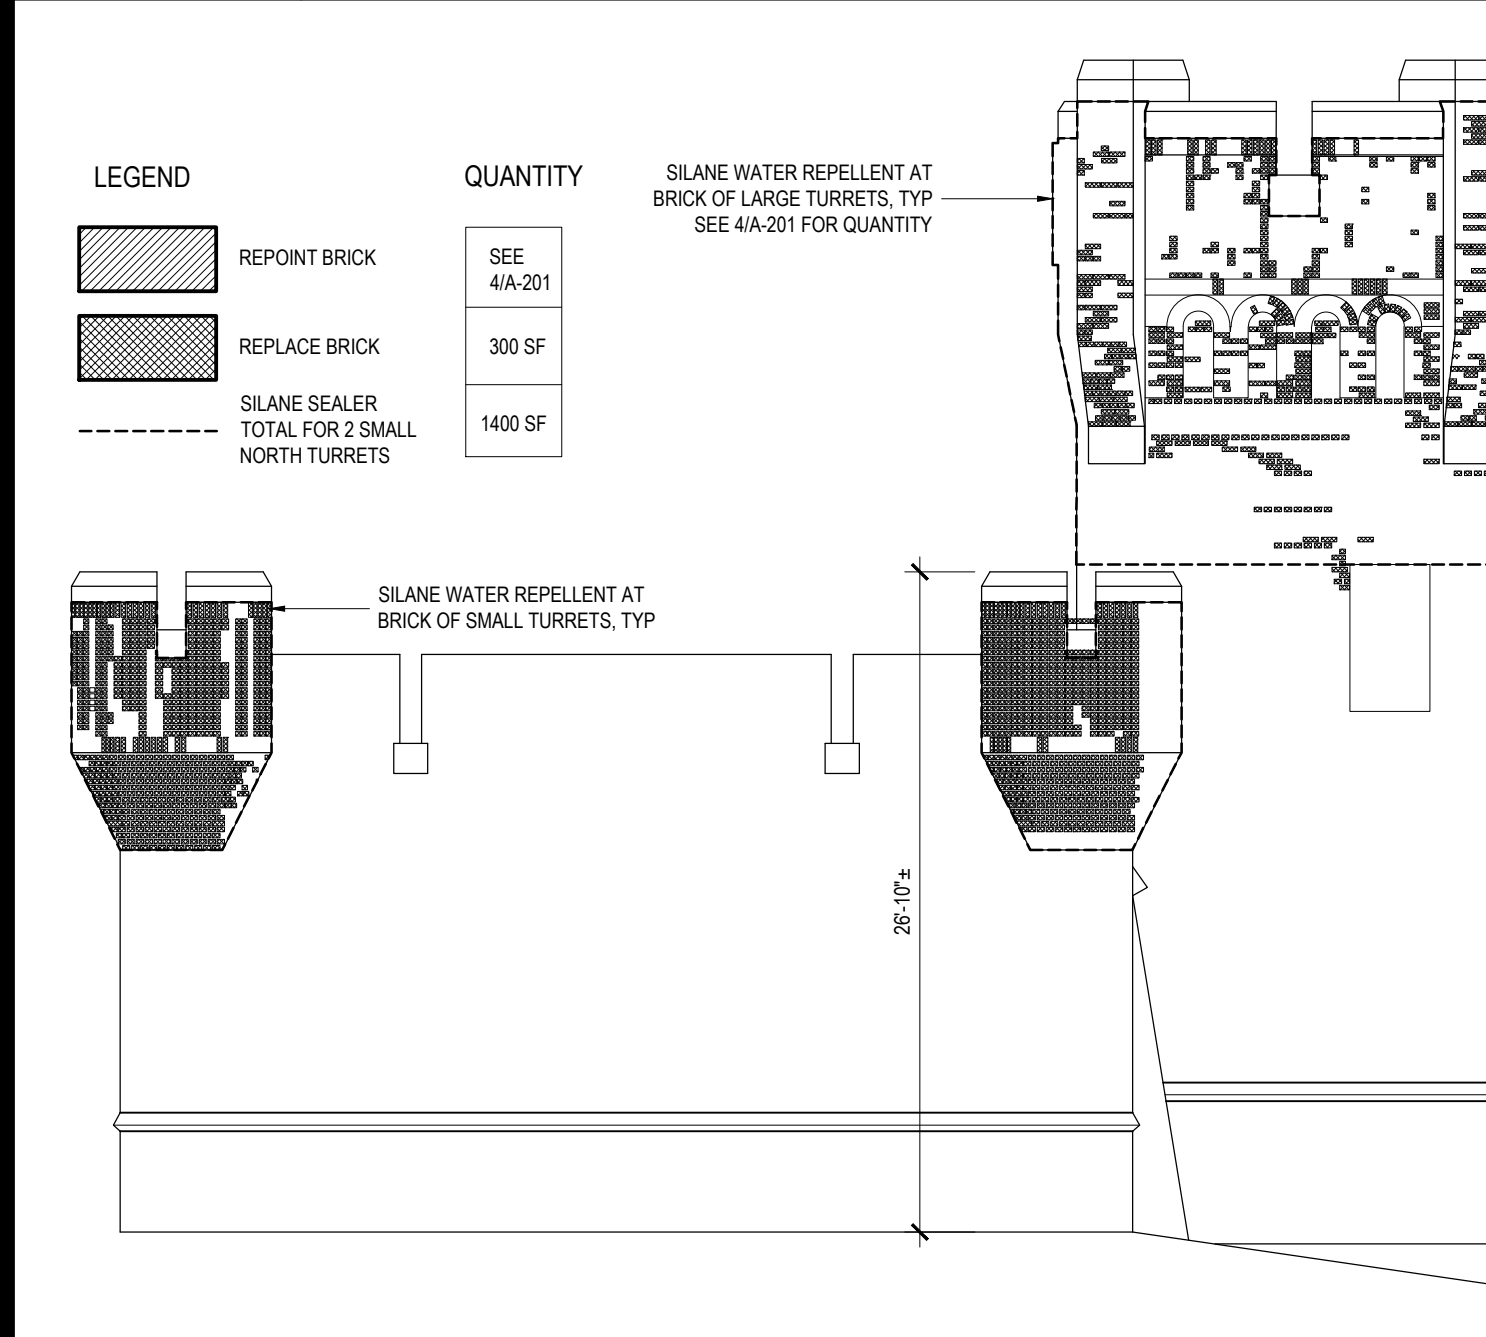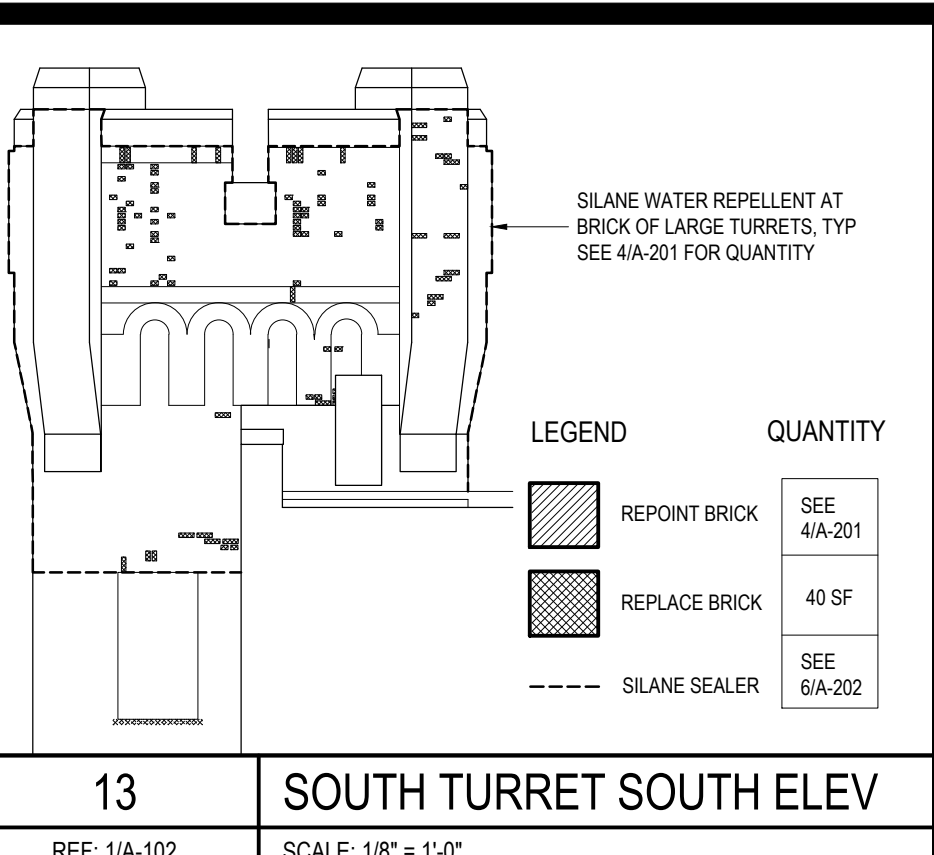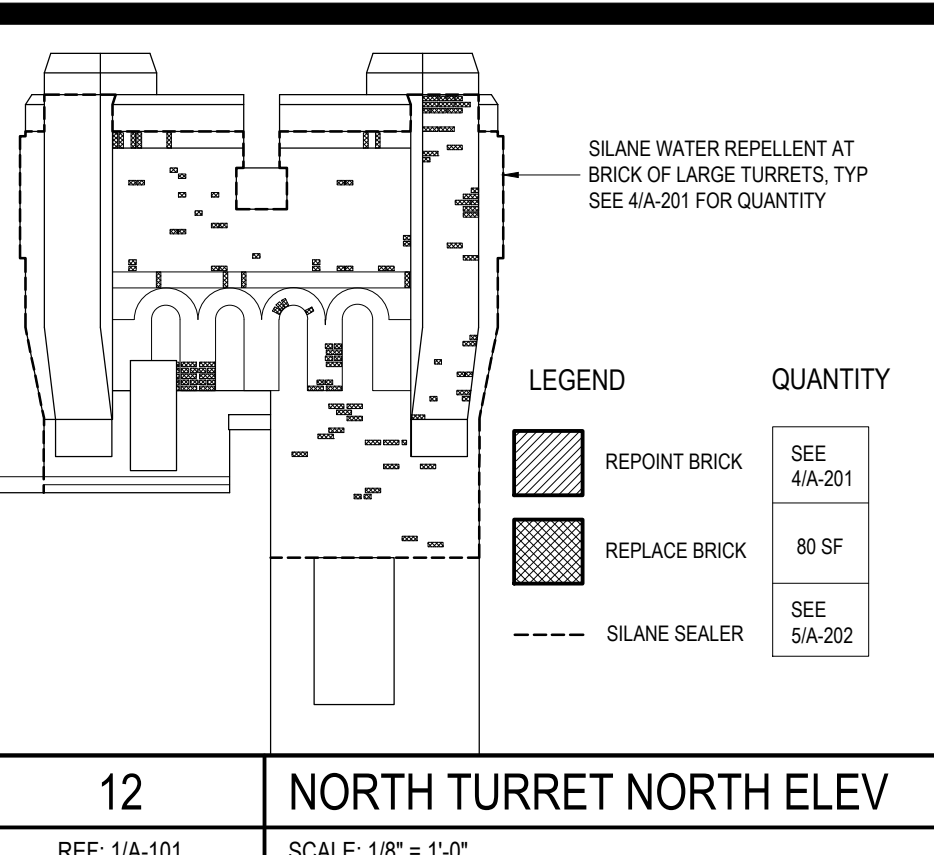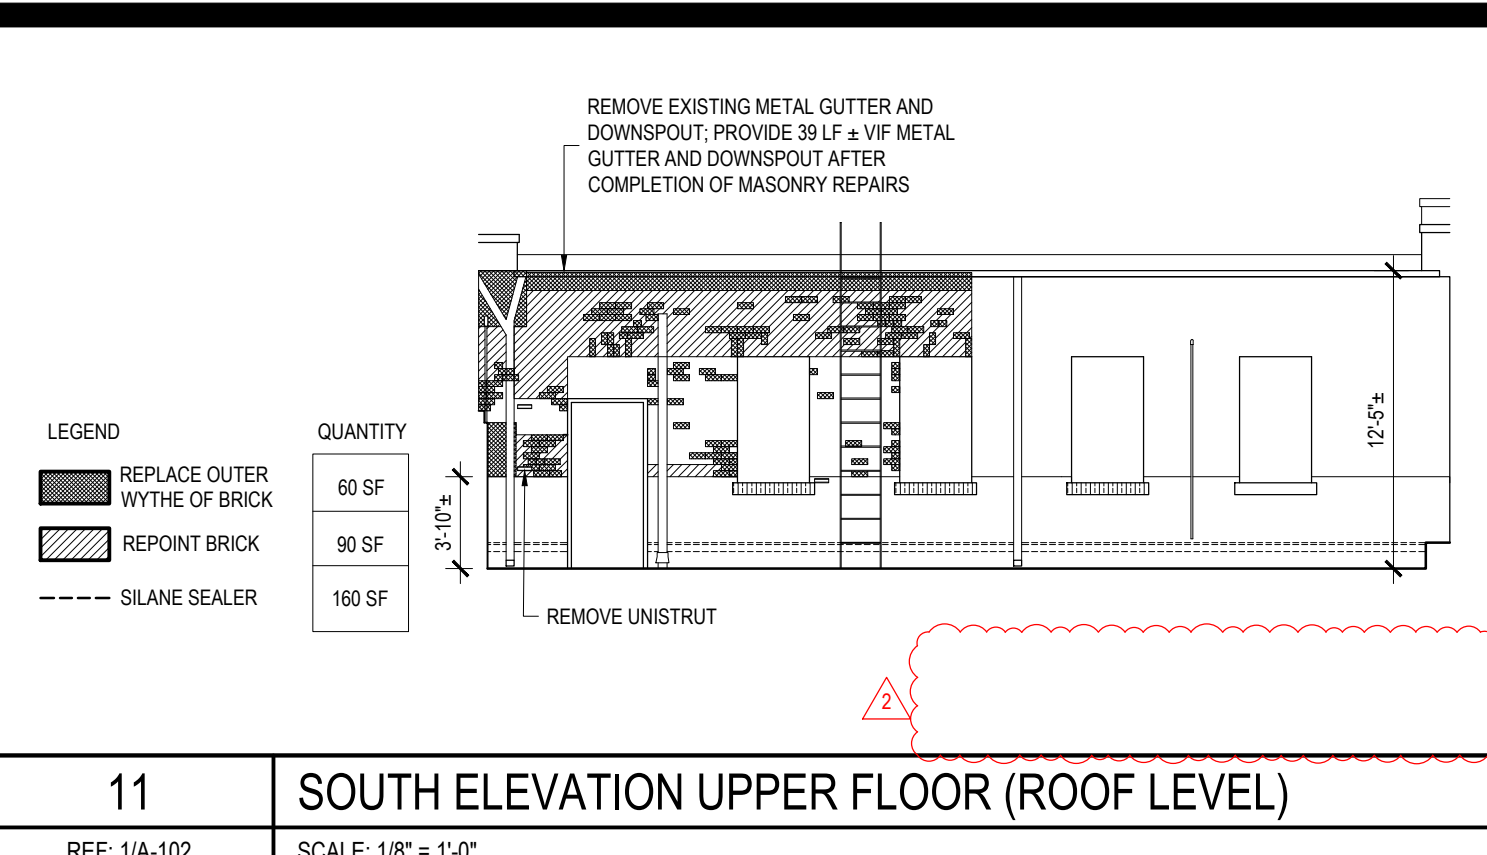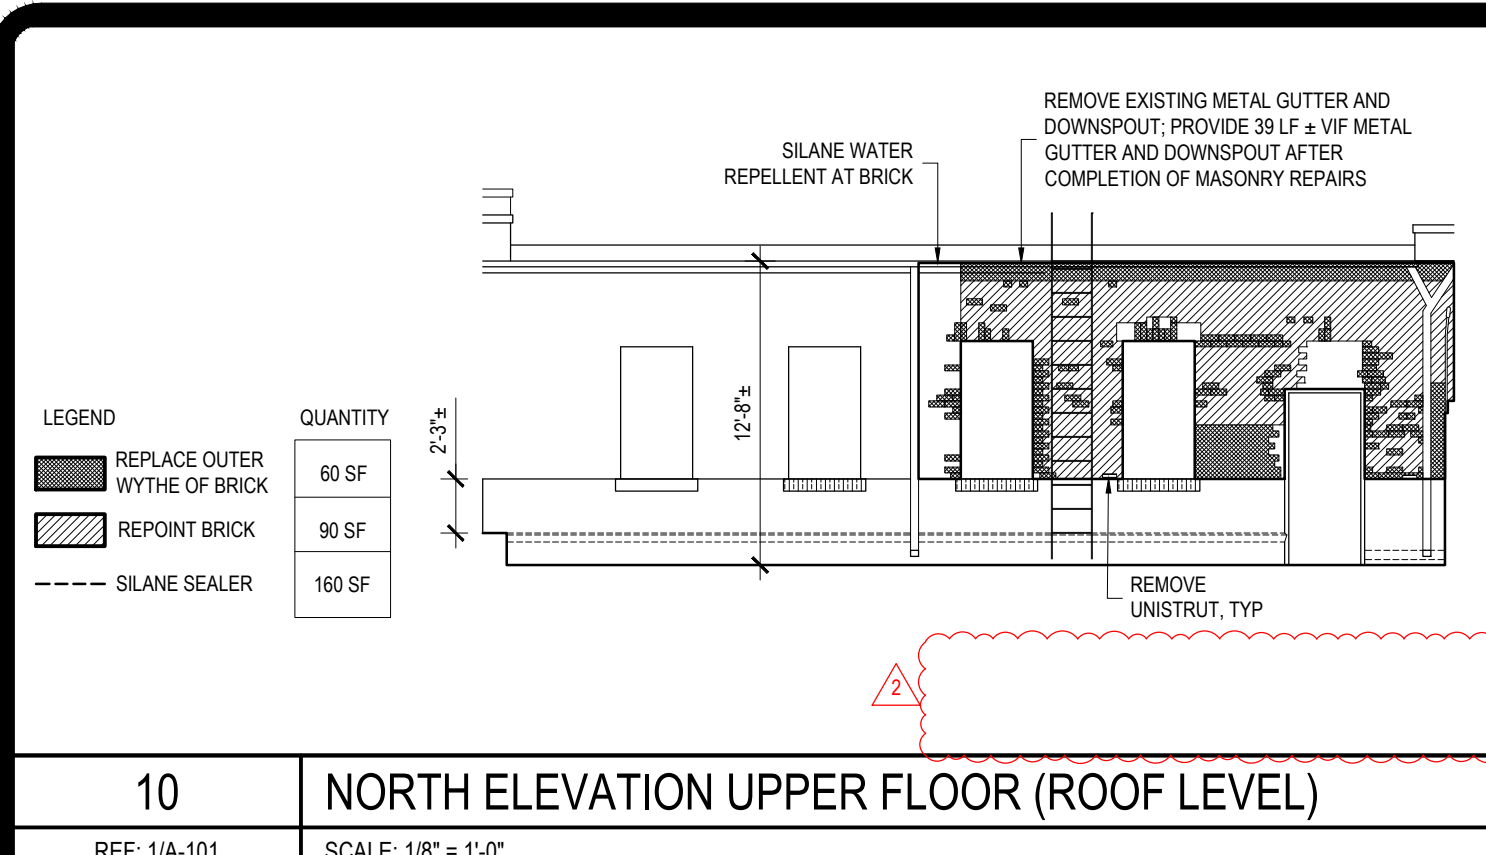

36x24 PLOT SHEET